Drain: BRIDLE WOOD ORAIN	Drain #:_ در
improvement/Arm: <u>Βκιριξωώο - Σέσημ</u> ο	y
Operator: <u>JpH</u>	Date: /0-30-03
Drain Classification: Urban/Rural Y	ear Installed: 1992

GIS Drain Input Checklist

•	Digitize d	& 1	Attribute	Tile	Drains	
---	------------	-----	-----------	------	--------	--

Digitize & Attribute Storm Drains

Digitize & Attribute SSD

• Digitize & Attribute Open Ditch

• Sum drain lengths & Validate

Enter Improvements into Posse

• Enter Drain Age into Posse

• Sum drain length for Watershed in Posse

Stamp Plans

• Pull Source Documents for Scanning

NA

Q.74 10-30

JERT 10-30

94 10-30

OPA 10-30

Jung 11-21

19-30

9th 10-30

965. - 9200 - 1150

Gasb 34 Footages for Historical Cost <u>Drain Length Log</u>

Drain-Improvement: BRIDLEWOOD DRAIN -SECTION Y

Orain Type:	<u>C:</u>	Length SURVEYERS (MANT/AS-BUILTS)	Length	Length		
rain Type:	Size:	(ALPORT AS-BUILTS)	(DB Query)	Reconcile	Price:	Cost:
550	6"	6504'	6054'	-450'		
RCP	12."	1325'	1325'	ø		
	15"	599'	599'	ø		
	18"	409'	4091	8		
	21	53 •	53'	Ø		
10	24"	162'	162'	8		
PEN DITCH		5981	598'	Ø		
						<u></u>
	Sum:	9650'	9200	-460		
inal Report:						
omments:	مستعرفة مترسا ومراهم					
TULKSU CIENOTH FOR	JSU TRANSPOSI	ON FINAL REPO	ET FROM GOS	54. 70 GSOY.		





Kenton C. Ward, Surveyor

Suite 146

776-8495

One Hamilton County Square Noblesville, Indiana 46060-2230

October 16, 1992

To: Hamilton County Drainage Board

Re: Bridlewood Drain Sec. 4 Arm

Attached is a petition, non-enforcement request, plans, calculations, quantity summary and assessment roll for the Bridlewood Drain, Section 4 Arm. I have reviewed the submittals and petition and have found each to be in proper form.

I have made a personal inspection of the land described in the petition. Upon doing so, I believe that the drain is practicable; will improve the public health; benefit a public highway and be of public utility; and that the costs, damages and expenses of the proposed drain will probably be less than the benefits accruing to the owners of land likely to be benefitted. The drain will consist of the following:

Open Ditch 598' 15" RCP 595' 6" SSD 7054' 18" RCP 410' 12" RCP 327' 21" RCP 218'

The total length of the drain will be 9202 feet.

Included in the above as open ditch is the portion of Cool Creek which borders this section of the subdivision. Also all of the 6" SSD was included including that under curbs. The length my change with the "as-builts".

I have reviewed the plans and believe the drain will benefit each lot equally. Therefore, I recommend each lot be assessed equally. I recommend a maintenance assessment of \$50.00 per lot, \$5.00 per acres for roadways, with a \$50.00 minimum. With this assessment the total annual assessment for the drain this section will be 2,205 00 \$2,245.00.

I recommend a hearing be set for December 1992. If approved at hearing, I recommend the Board approve the attached non-enforcement for this section of Bridlewood. I further recommend the Board classify this as an urban drain.

3

Kenton C. Ward

Hammilton County Surveyor

KCW/jh

Irrevocable Letter of Credit

INB National Bank One Indiana Square Indianapolis, Indiana 46266



1 ***	
SWIFT Address: INBI US 44 Telex Number 205615 Phone: 266-6150	SB 035900 Credit Number Advising Bank No.
Advising Bank	Applicant
	Land Innovators
	234 S. Franklin Road
	Indianapolis Indiana 46219
Beneficiary	Amount
Hamilton County Commissioners	·
Hamilton County Drainage Board and the	USD 147,870.00
Westfield Town Board of Trustees	Expiration Date
One Hamilton County Square	September 25,1993
Noblesville, Indiana 46060 We hereby issue in your favor this irrevocable letter of credit which is available.	-
Drafts drawn at—sight	
on <u>INB National Bank, Indianapolis, Indian</u>	3
bearing the clause; "Drawn under irrevocable letter of credit No. ${\sf SB}$	3590 0
Other documents:	33300
	g that drainage improvements in Bridlewood
Section 4 have been completed in accordance	
docket approval #, by and 1	between Applicant and Beneficiary.
Special Conditions:	
We hereby engage with 😡 You 🗆 drawers and/or bona fide holders that drafts drawn and negotiated in conformity with the terms of this credit will be duly honored	Advising Bank's Notification
on presentation and that drafts accepted within the terms of this credit will be duly	
honored at maturity. The amount of each draft must be endorsed on the reverse of this credit by the	
negotiating bank.	
The Advising Bank is requested to notify the beneficiary without adding their confirmation.	
gunda Whieman	

Place/date/name/signature of advising bank.

320-6320 Revised 4/69

Place/date/name/signature of advising bank.

ORIGINAL.

CERTIFICATE OF COMPLETION AND COMPLIANCE

TO: HAMILTON COUNTY SURVEYOR

RE: Bridlewood Section 4

I hereby certify that:

- 1.) I am a Registered Land Surveyor in the State of Indiana,
- 2.) I am familiar with the plans and specifications for the above reference subdivision.
- 3.) I have personally observed and supervised the completion of the Drainage Facilities for the above referenced subdivision and
- 4.) To the best of my knowledge, information and belief, the Drainage Facilities within the subdivision has been installed and completed in conformity with the plans and specifications.

Signature:	an	Date:	October	17,	1995
Type or Printed Name: Arthur L.	Kaser				
Business Address: 234 S. Frankl	in Road				
Indianapolis,	Indiana	46219			
Telephone: (317) 353-6161		··		*************	·
	188378888	131624.			

INDIANA REGISTRATION NUMBER

S0529







Kenton C. Ward, Surveyor

Phone (317) 776-8495

Fax (317) 776-9628

Suite 146 One Hamilton County Square Noblesville, Indiana 46060-2230

July 23, 1996

TO: Hamilton County Drainage Board

RE: Bridlewood Drain-Section 4

Attached are As-Builts, Certificate of Completion and Compliance, and other information for Bridlewood Drain-Section 4. An inspection of the drainage facilities for this section has been made and the facilities were found to be complete and acceptable.

During construction, changes were made to the drain which will alter the plans submitted with my report for this drain dated October 16, 1992. The changes are as followed:

```
STR 79 to 80
              1.2"
                   RCP
                        lengthened from
                                          44' to
                                                  47 feet ✓
STR 73 to 72
              21"
                   RCP
                        shortened from
                                          58' to
                                                  53 feet√
STR 72 to 71
                        shortened from
              18"
                   RCP
                                          26' to
                                                  24 feet√
              18"
                        lengthened from 160' to 161 feet
STR 71 to 70
                   RCP
STR 67 to 68
              12"
                   RCP
                        lengthened from 155' to 226 feet V
STR 74 to 75
              15"
                   RCP
                        lengthened from
                                          36' to
                                                  38 feet
              15"
                        lengthened from 115' to 117 feet
STR 76 to 77
                   RCP
                                          32' to
                                                 31 feet
STR 78 to 79
              18"
                   RCP
                        shortened from
                        lengthened from 192' to 193 feet
STR 79 to 47
              18"
                   RCP
```

The six (6") inch SSD across the rear of Lots 45 through 48 and Lots 37 to 39 were replaced with twelve (12") inch RCP. The following structures and lengths were added accordingly:

```
at 200 feet in length
STR 85 to 86
              12" RCP
                       at 235 feet in length
STR 86 to 69
              12" RCP
STR 84 to 81
              12" RCP
                          89 feet in length
                       at
              12" RCP
                       at 216 feet in length
STR 81 to 74
              12" RCP
                           24 feet in length
STR 83 to 82
                       at
              12" RCP
                       at 160 feet in length
STR 82 to 81
```

The correct total of six (6") inch SSD is 6,504 feet. Structure 73 to 48 consists of twenty-four (24") inch RCP at 162 feet in length. This structure was upgraded from a twenty-one (21") inch RCP at 160 feet in length.

Page #2

The length of the drain due to the changes described above is now 9,650 feet.

The non-enforcement request was approved by the Board at its meeting on December 21, 1992.

The Bond of Letter of Credit from Indiana National Bank, number SB 035900 dated September 25, 1992, in the amount of \$147,870.00 has expired.

I recommend the Board approve the drains construction as complete and acceptable.


Kenton C. Ward

Hamilton County Surveyor

KCW/no

CONSTRUCTION PLANS FOR BRIDLEWOOD SECTION IV

WASHINGTON TOWNSHIP, HAMILTON COUNTY, INDIANA

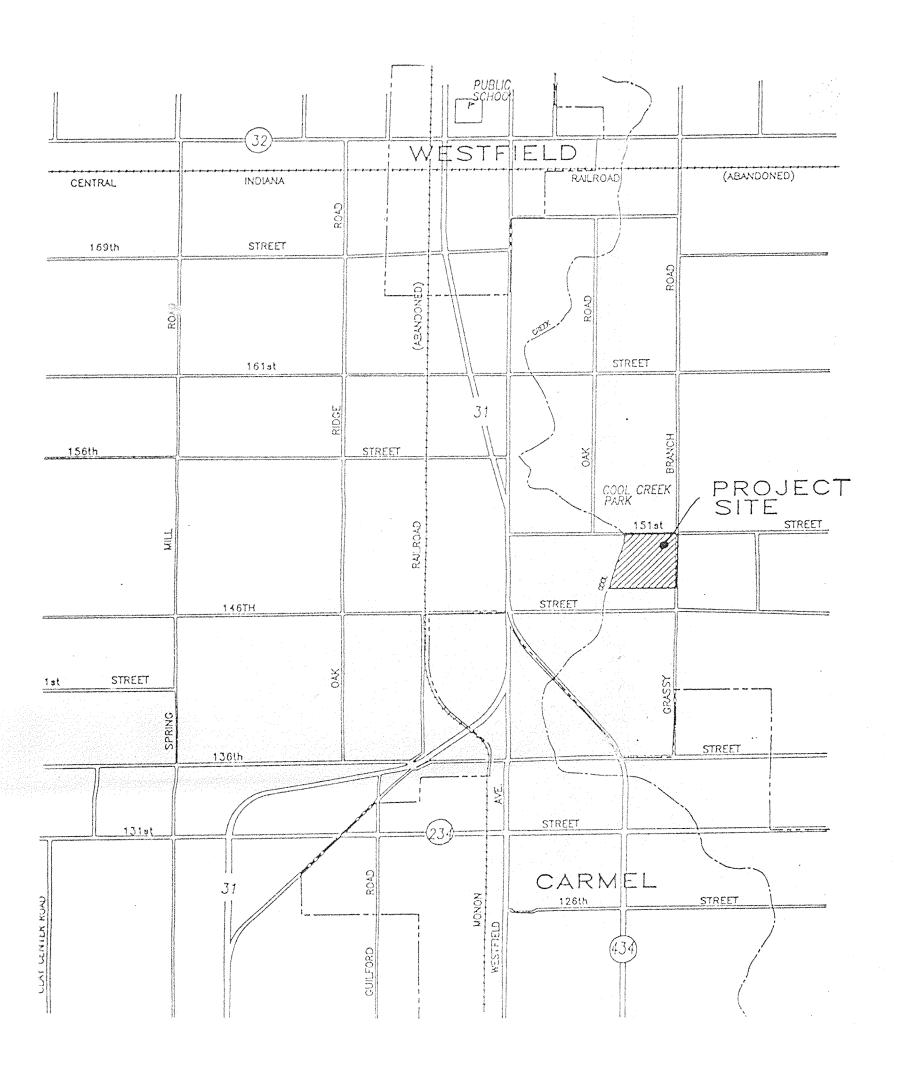

INDEX REVISIONS DESCRIPTION DESCRIPTION No. DATE 1 COVER SHEET 7-17-92 REVISED STORM PER HAM. CO. HWY. 2 PLAT 11-10-92 APP SECTION A'-A' & NOTES (ENTRANCE DETAIL 3 MASTER SEWER & WATER PLAN 4 SITE PLAN 5 EROSION CONTROL PLAN 6 BRIDLEWOOD DR. & SADDLEHORN DR. 7 SADDLEHORN CT. & WINDMILL DR. 8 BRIDLEWOOD CIR. & STORM STRS. 69-73, 48 9 STORM STRUCTURES 47, 74 - 86 10 ENTRANCE DETAIL 11 INTERSECTION & CUL-DE-SAC DETAILS 2 SPECIFICATIONS ASC. STANDARD DETAILS 13A SEWER DETAILS

This copy printed from the Digital Archive of the Hamilton County Surveyor's Office; One Hamilton Co. Square, Ste. 188, Noblesville, In 46060

DESIGN DATA

No. of Lots = 44 Area = 22.818 ac. Density = 1.928 lots/ac.

BRIDLEWOOD DRIVE = 250.40 feet = 0.0474 miles
BRIDLEWOOD CIRCLE = 279.00 feet = 0.0528 miles
SADDLEHORN DRIVE = 1471.66 feet = 0.2787 miles
SADDLEHORN COURT = 447.73 feet = 0.0847 miles
WINDMILL DRIVE = 219.00 feet = 0.0415 miles
TOTAL = 2667.49 feet = 0.5052 miles

PREPARED FOR:
R. N. THOMPSON AND ASSOC., INC.
234 S. FRANKLIN ROAD
INDIANAPOLIS, INDIANA 46219

PREPARED BY:
ARTHUR L. KASER
PROFESSIONAL LAND SURVEYOR
IND. REG. NO. S0529

CERTIFIED BY: Auch L. Kan DATE: 6-12-92

INDIANA DEPARTMENT OF HIGHWAYS
STANDARD SPECIFICATIONS LATEST EDITION
TO BE USED WITH THESE PLANS


FILED

DEC 06 1993
OFFICE OF HAMILTON COUNTY SURVEYOR





234 SOUTH FRANKLIN RD., INDIANAPOLIS, INDIANA 46219
317/353-6161




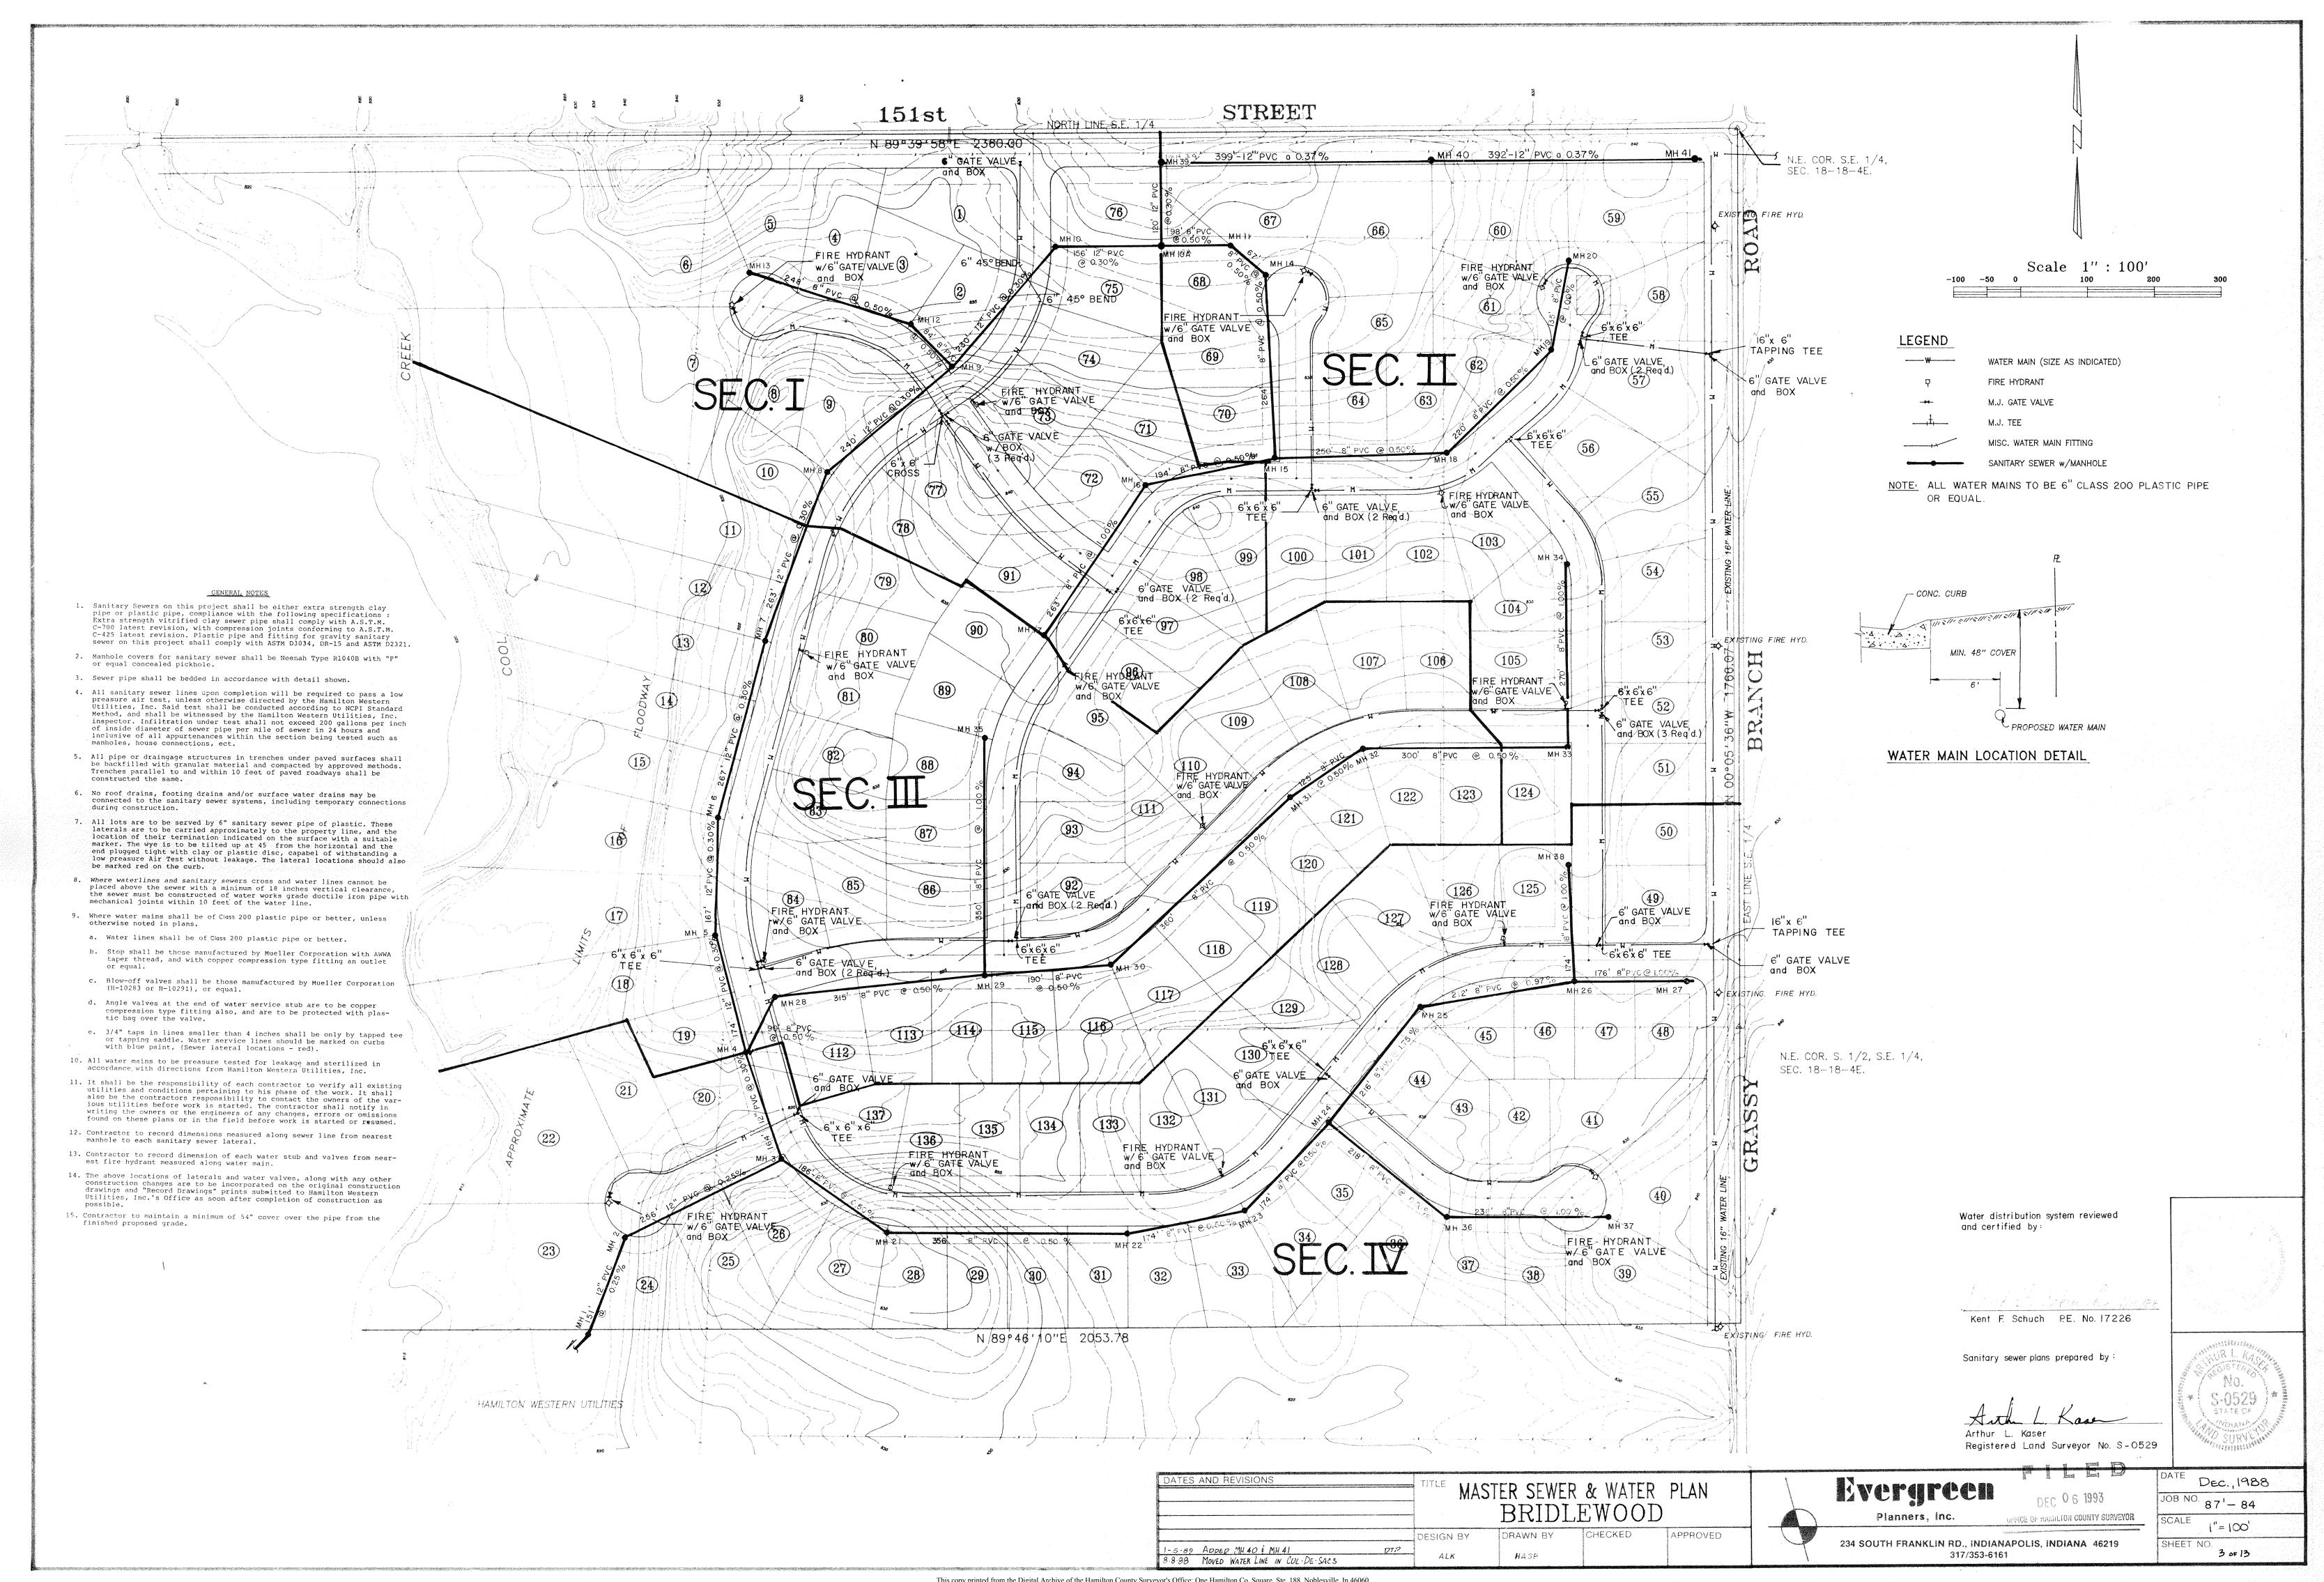





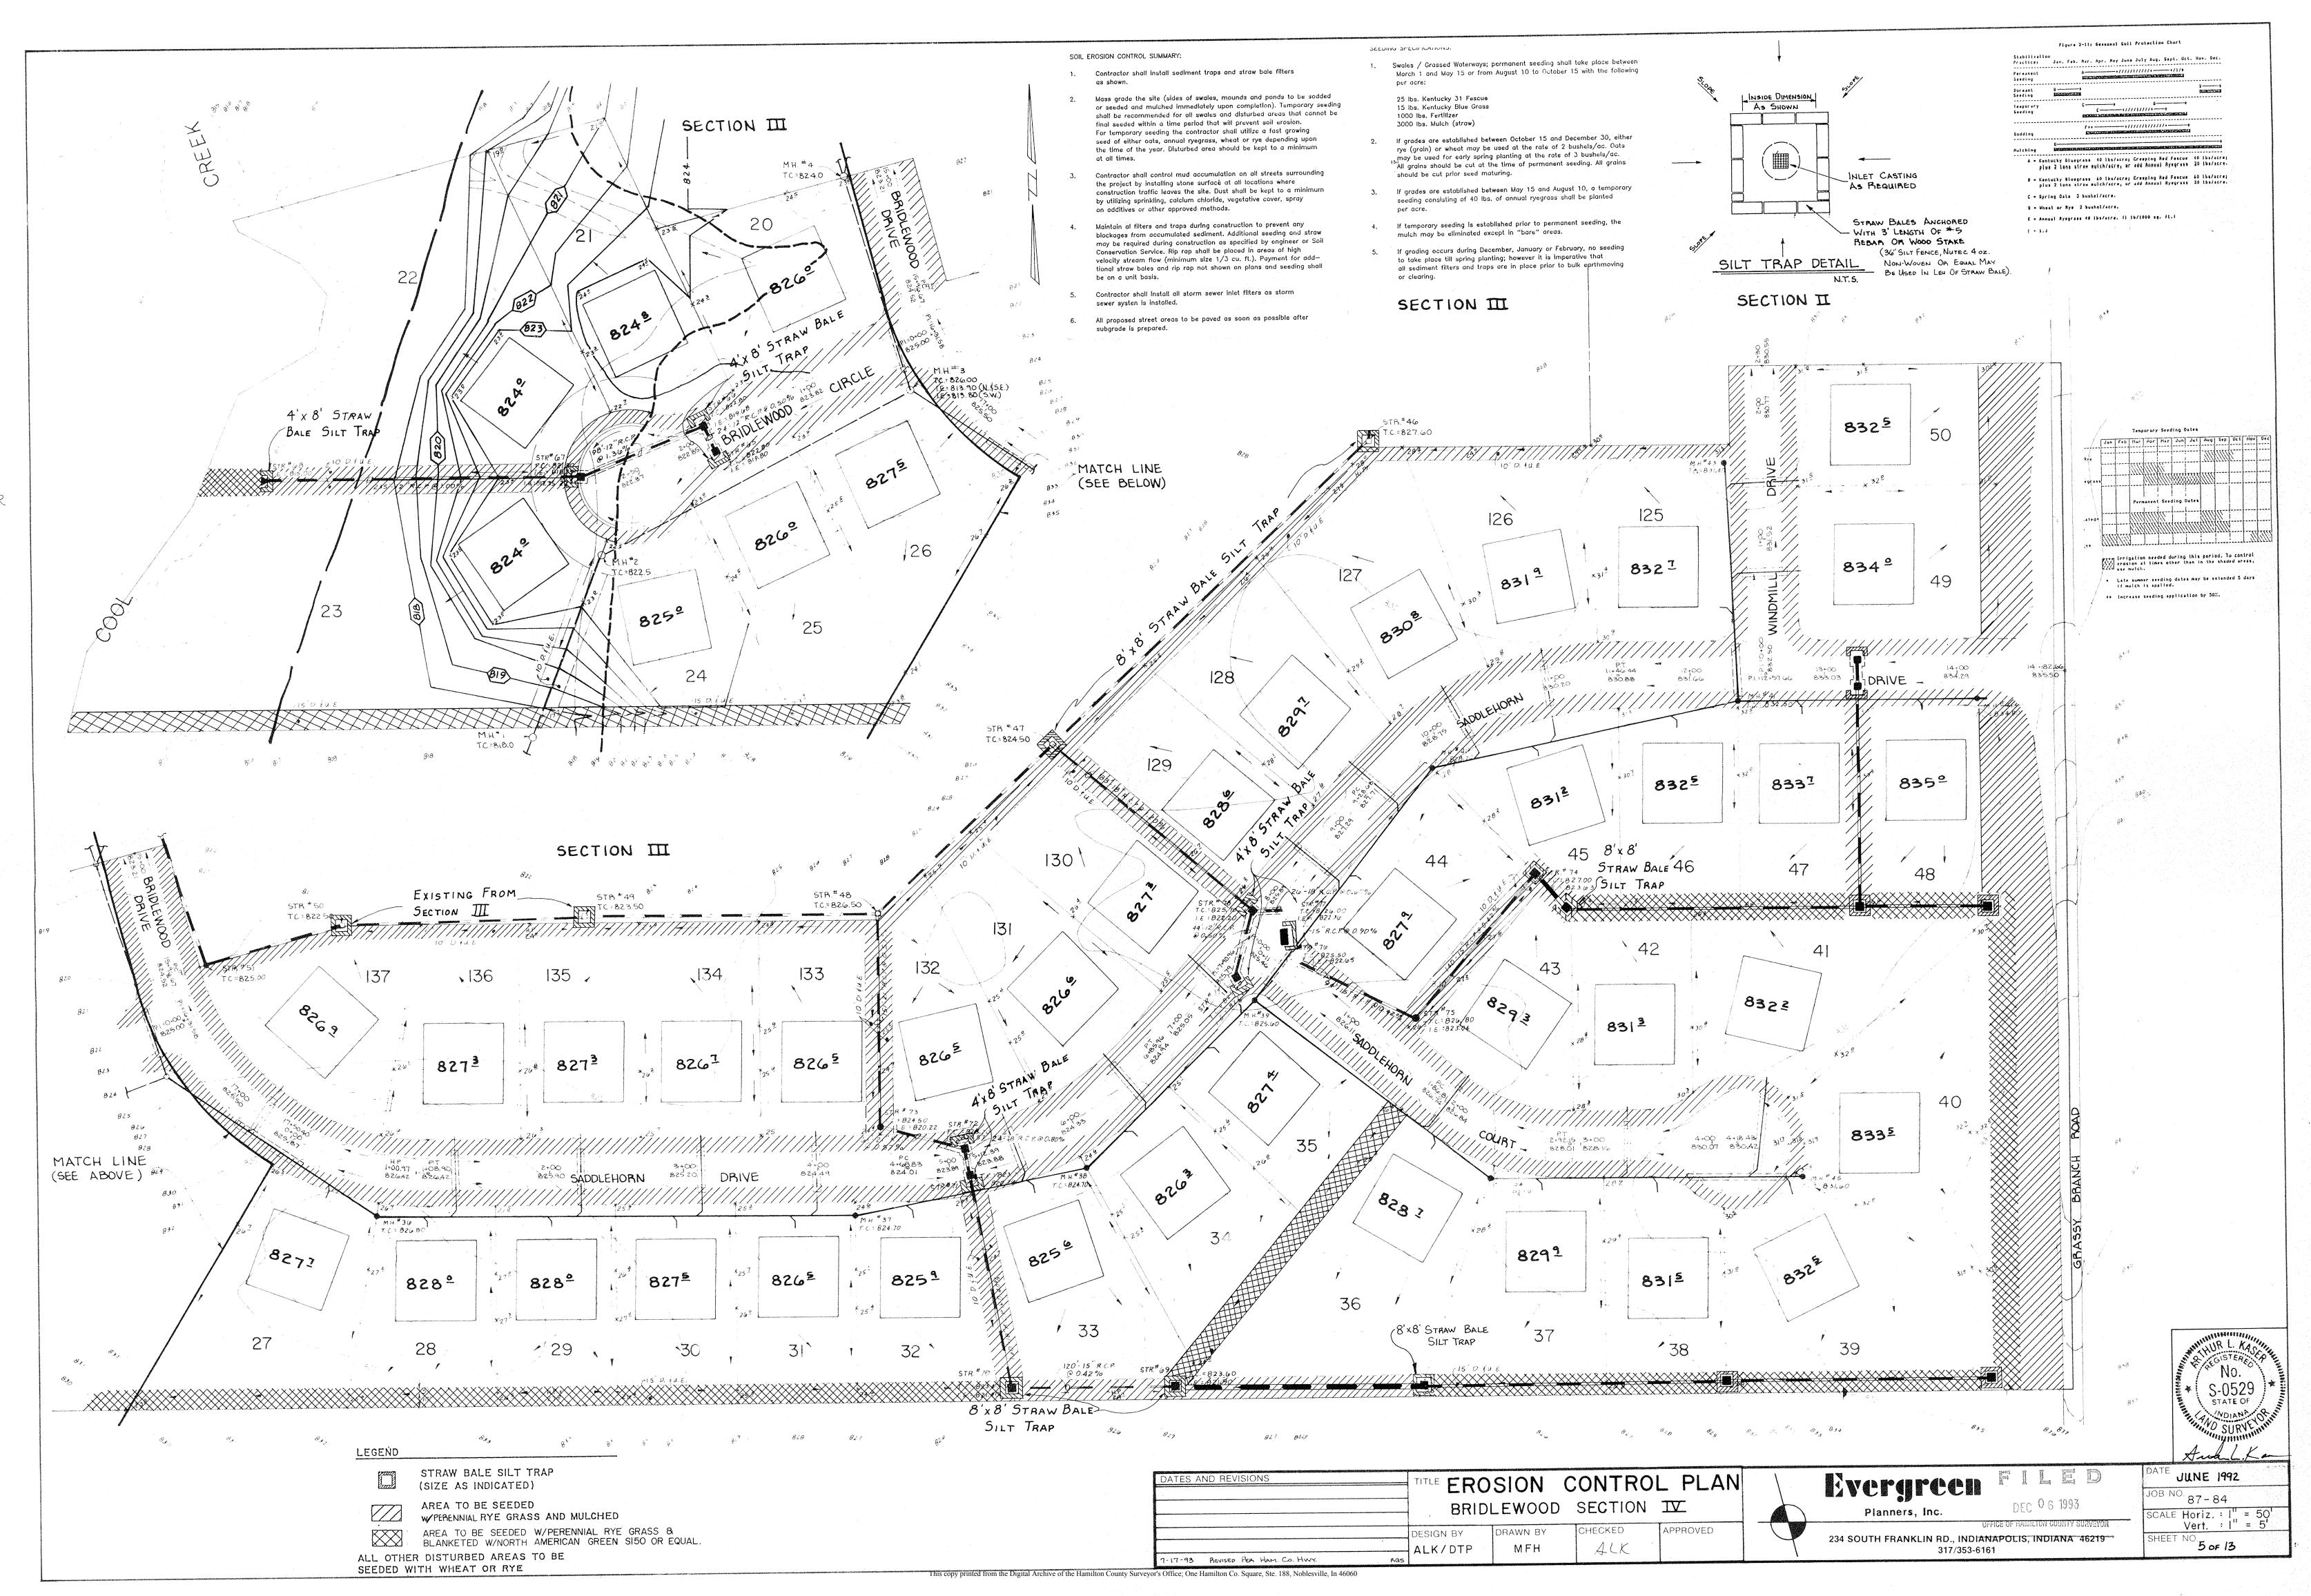


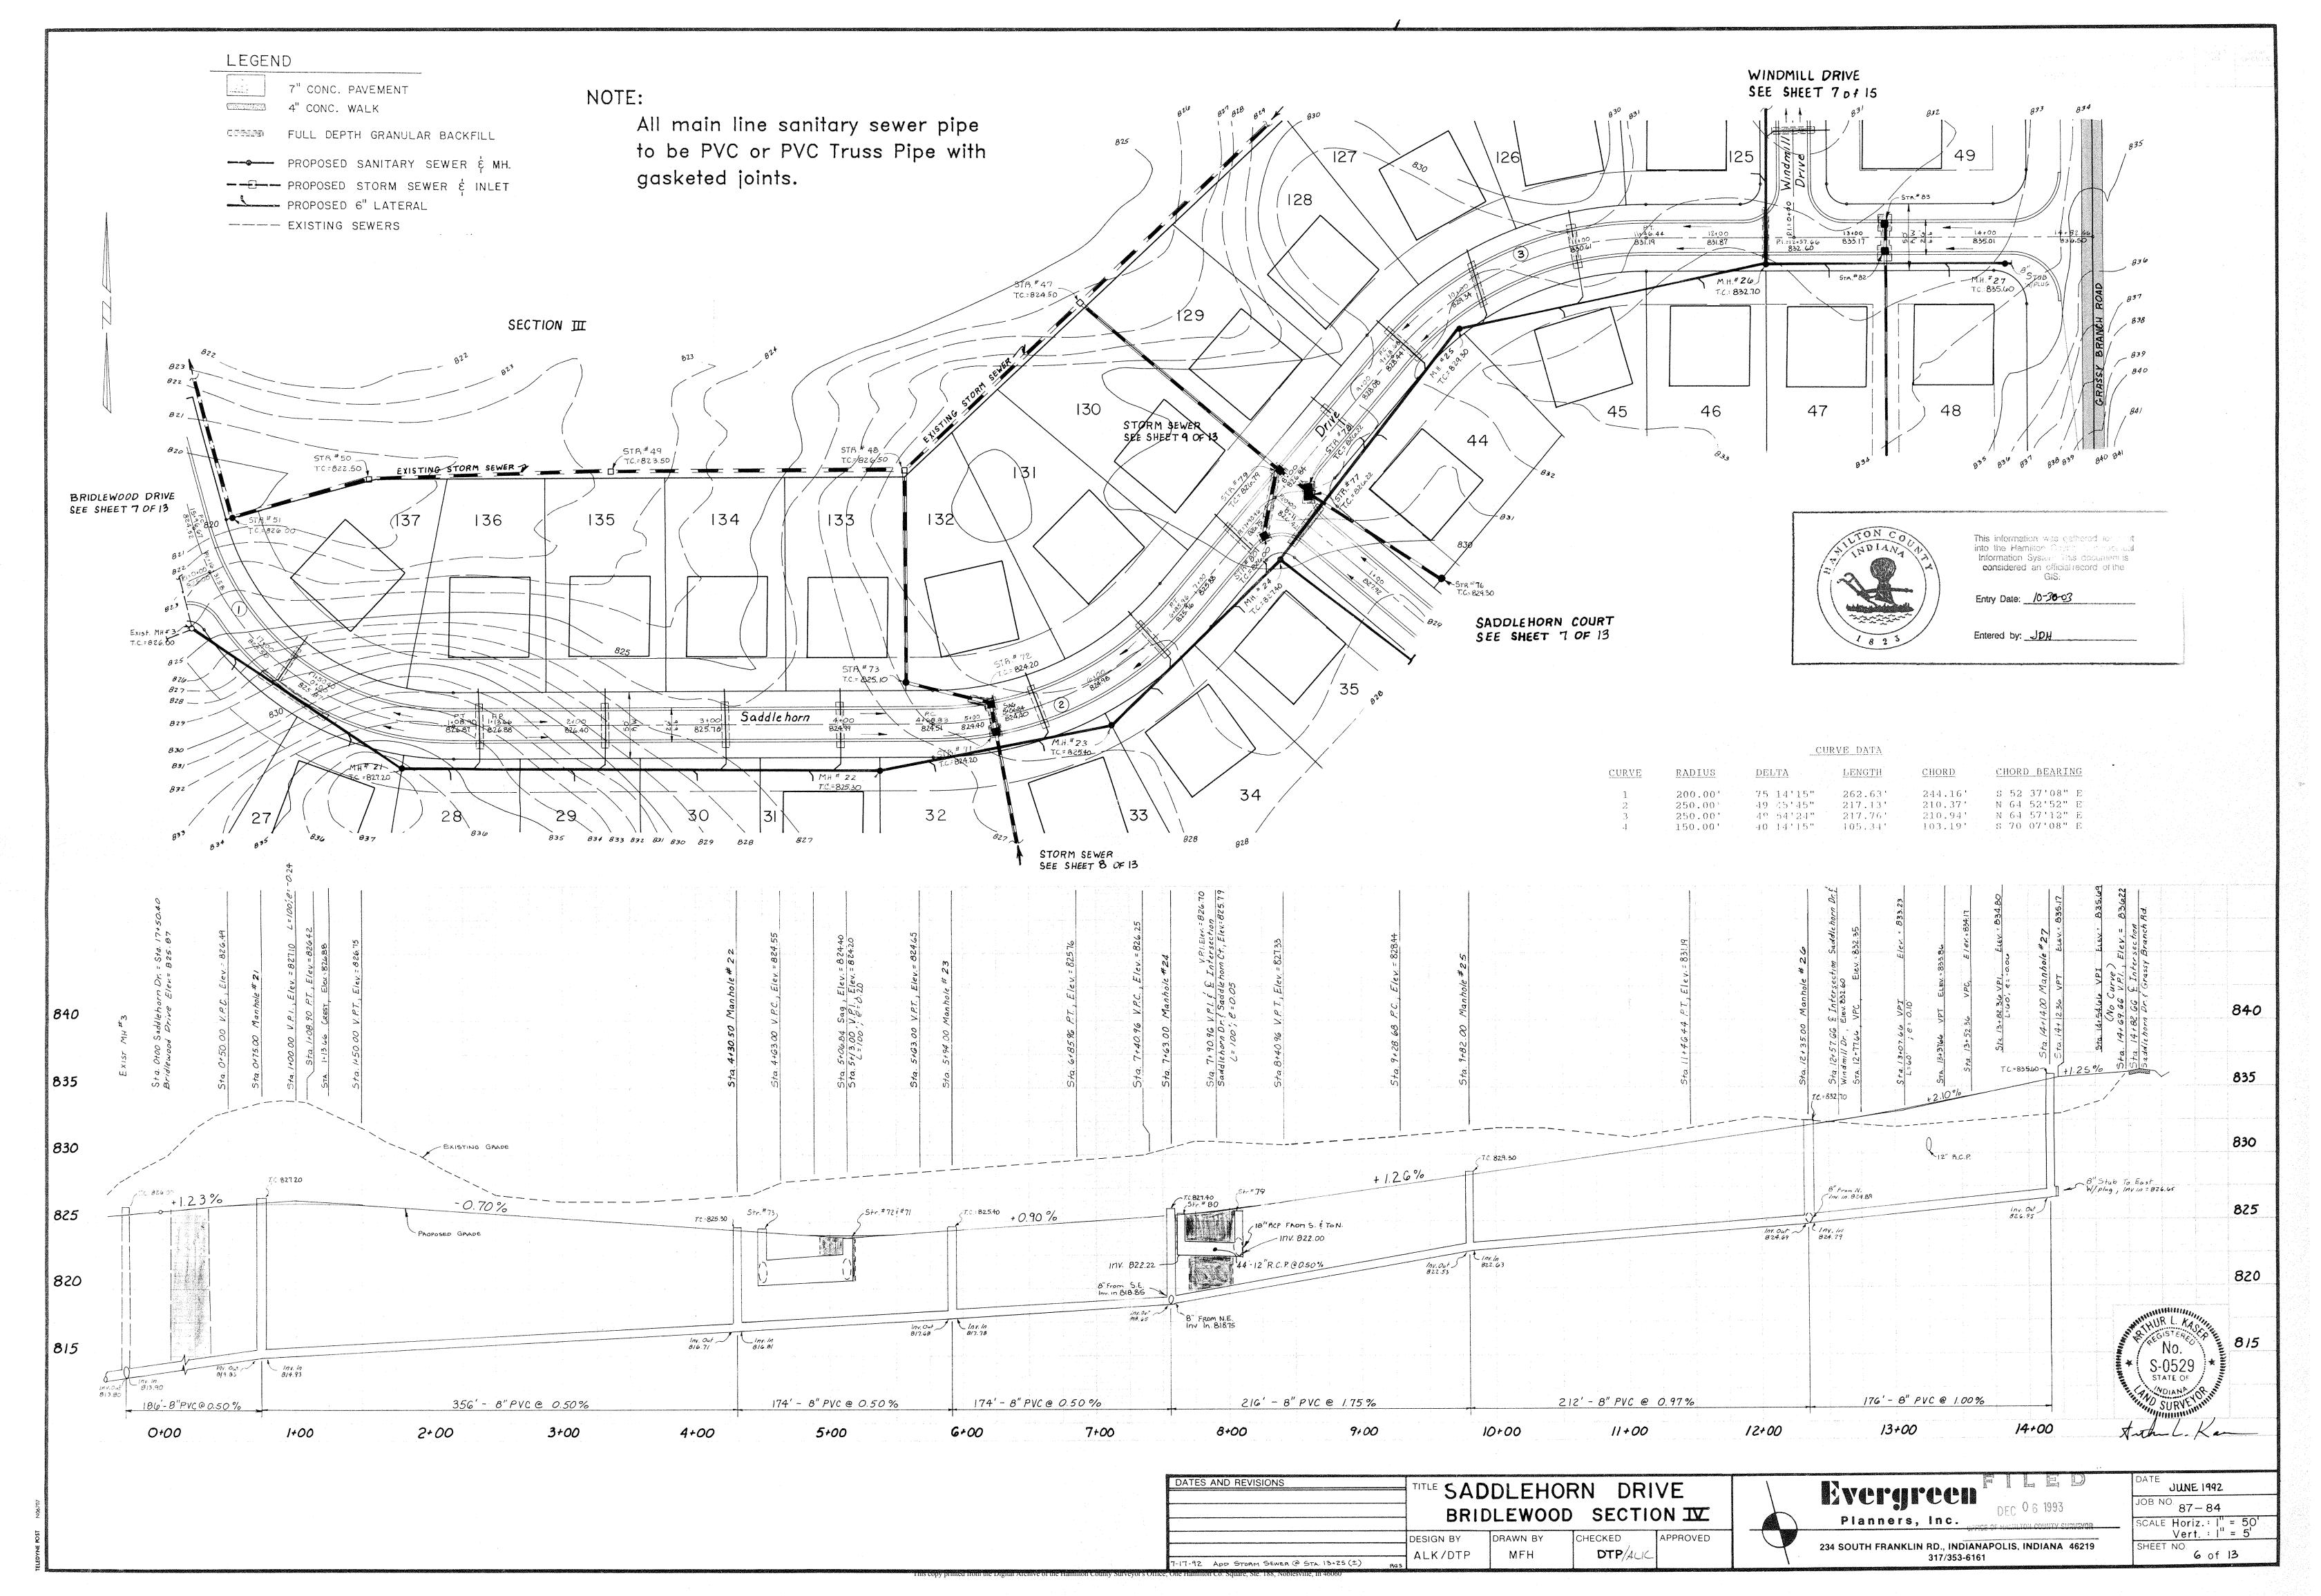

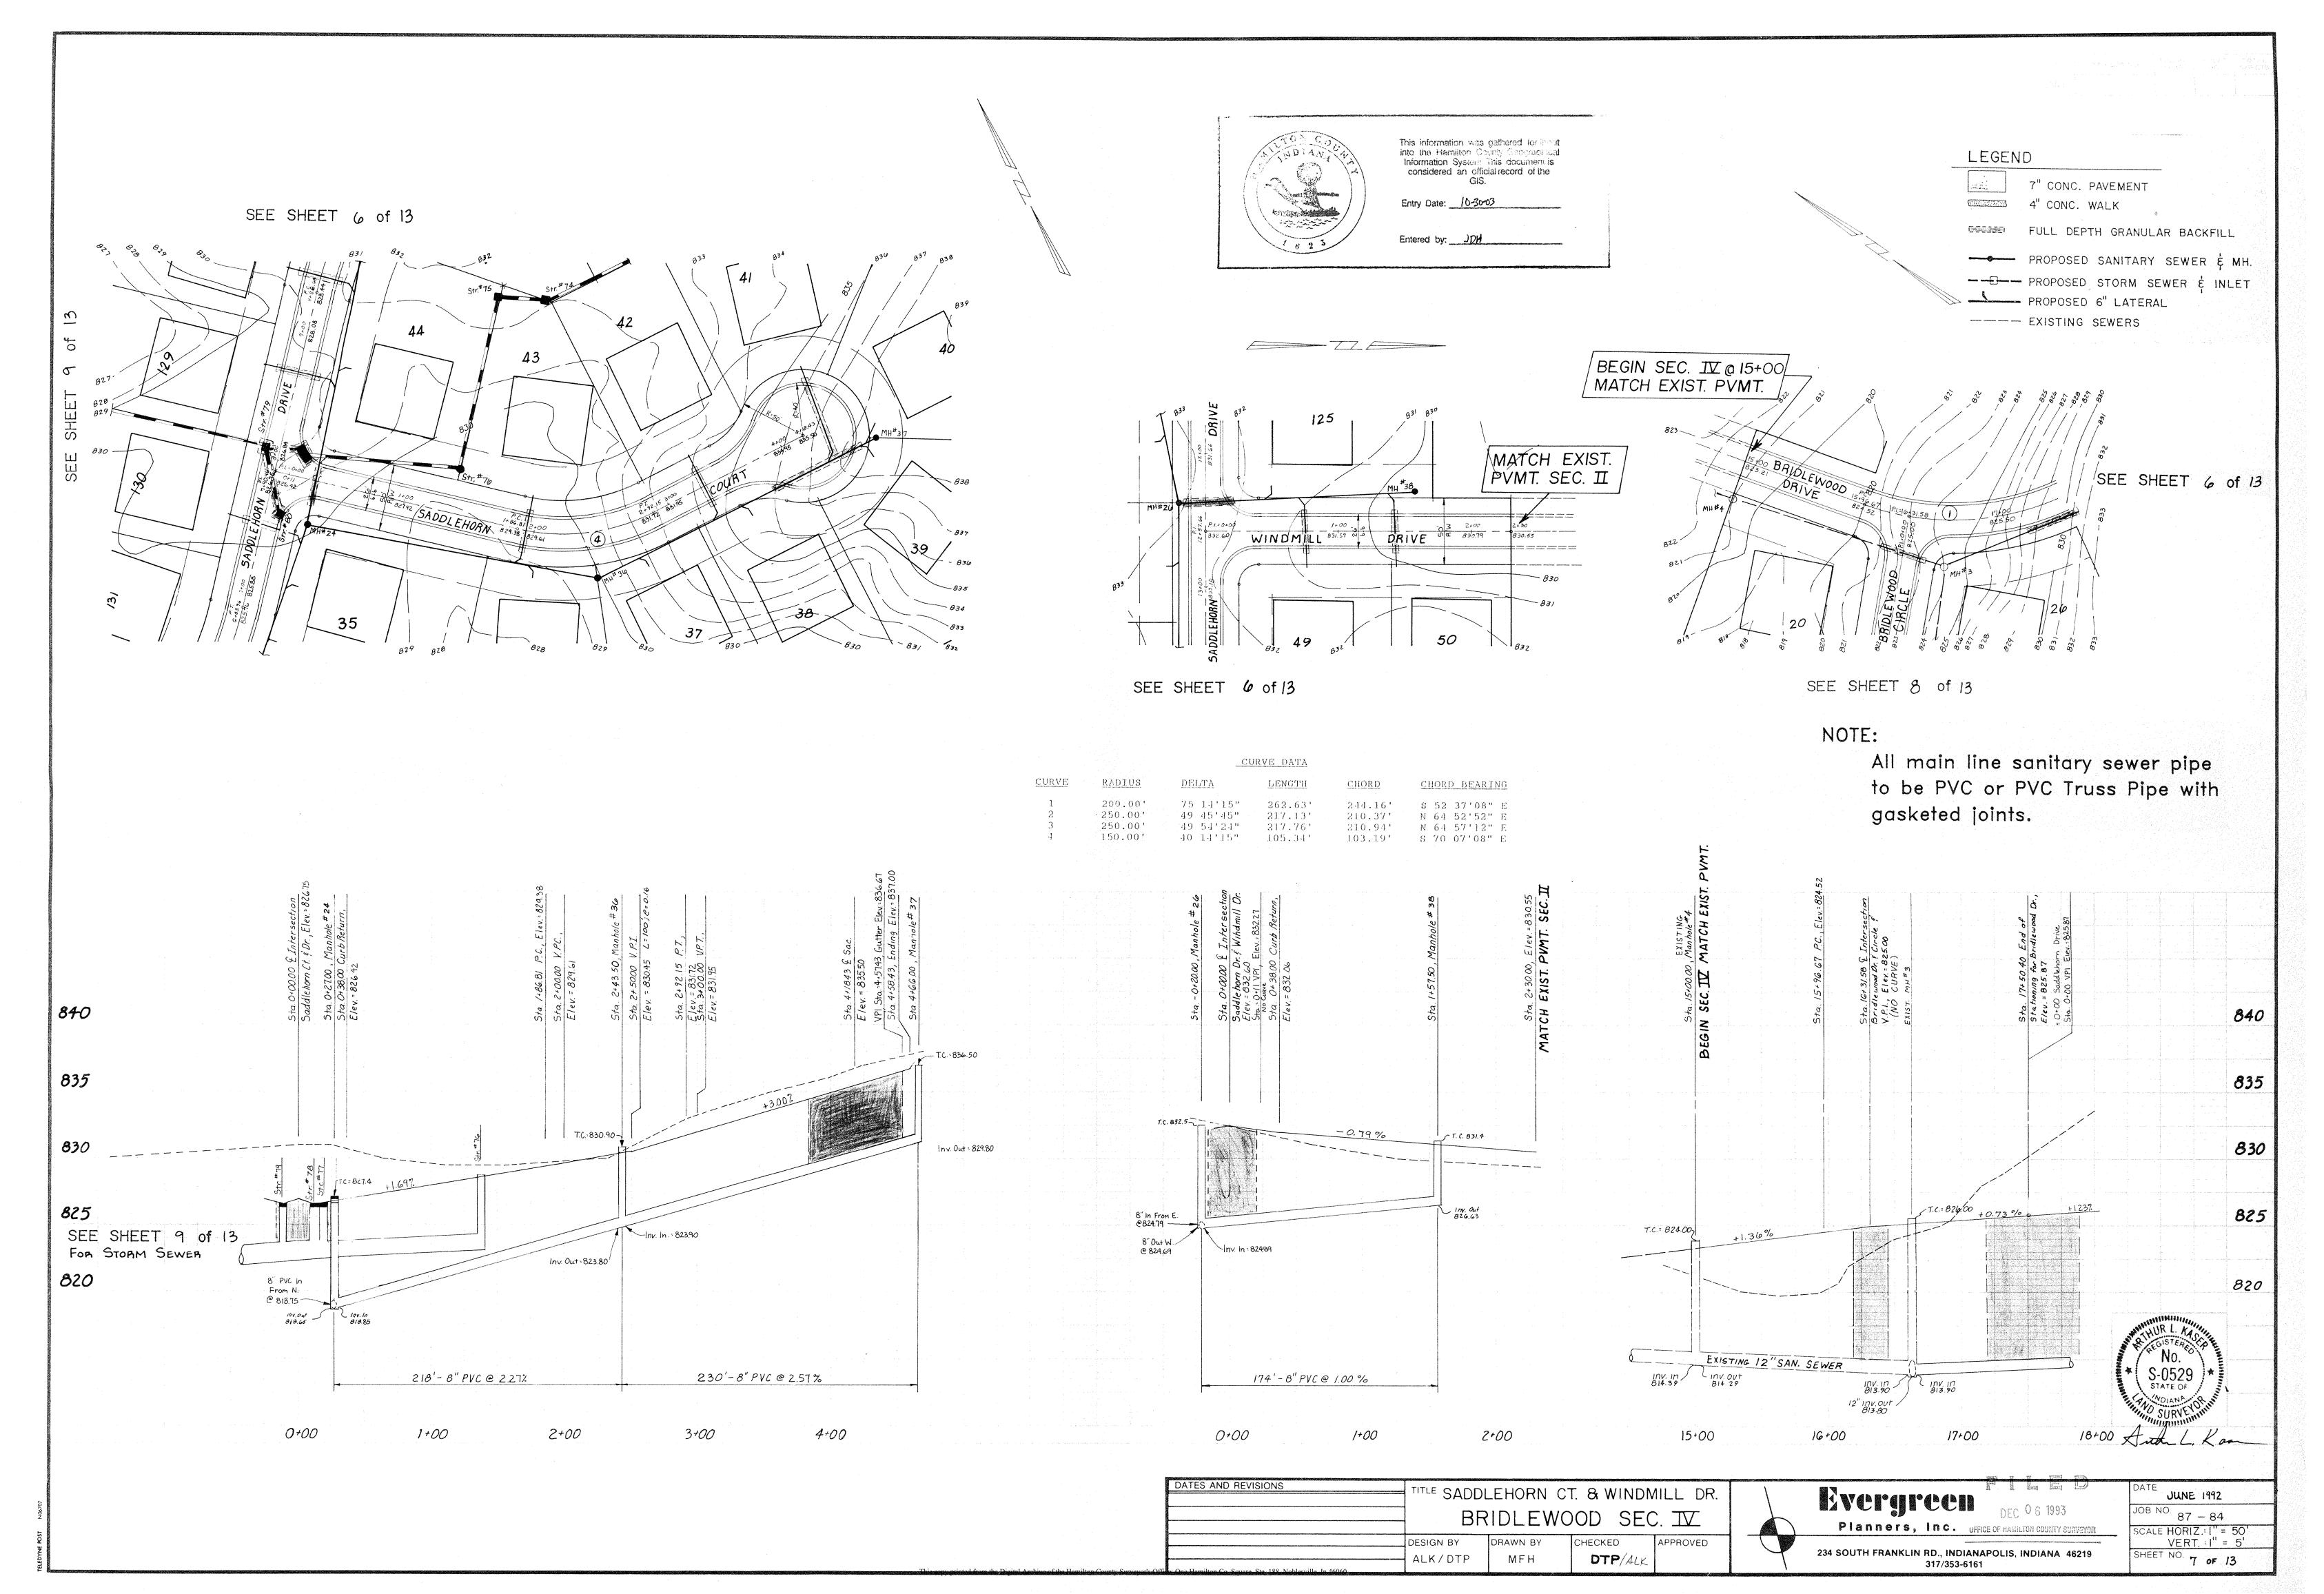

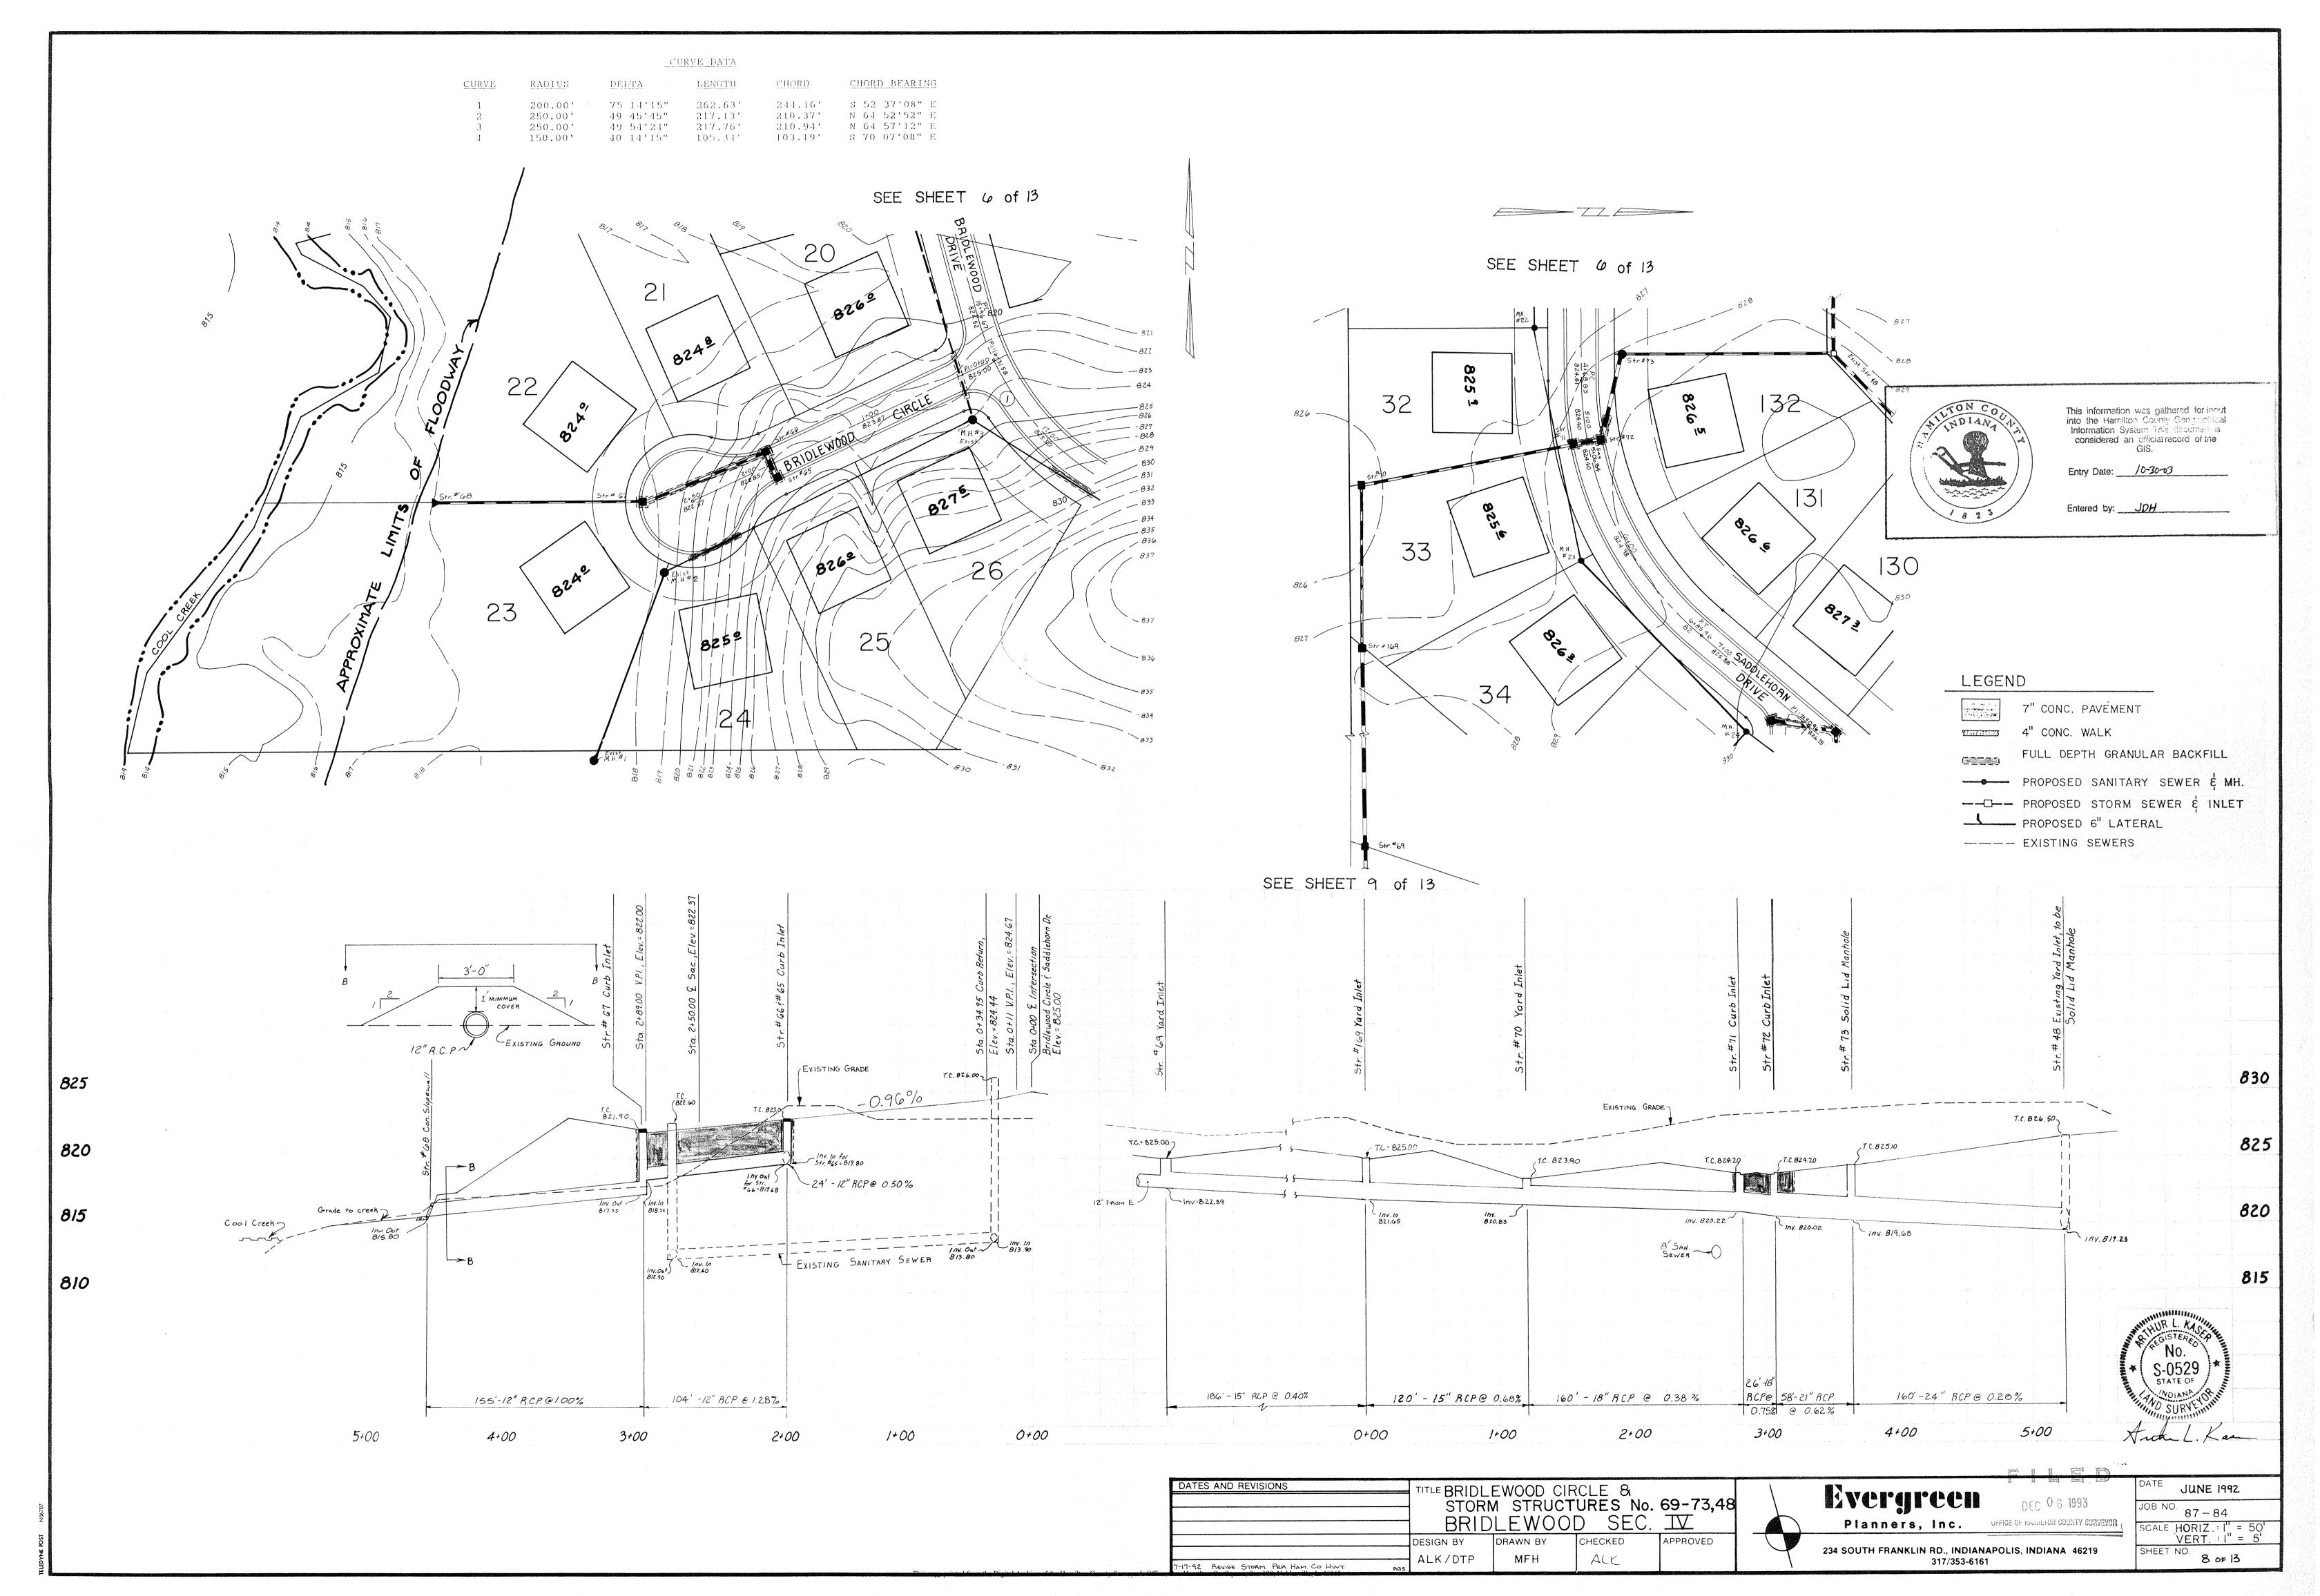

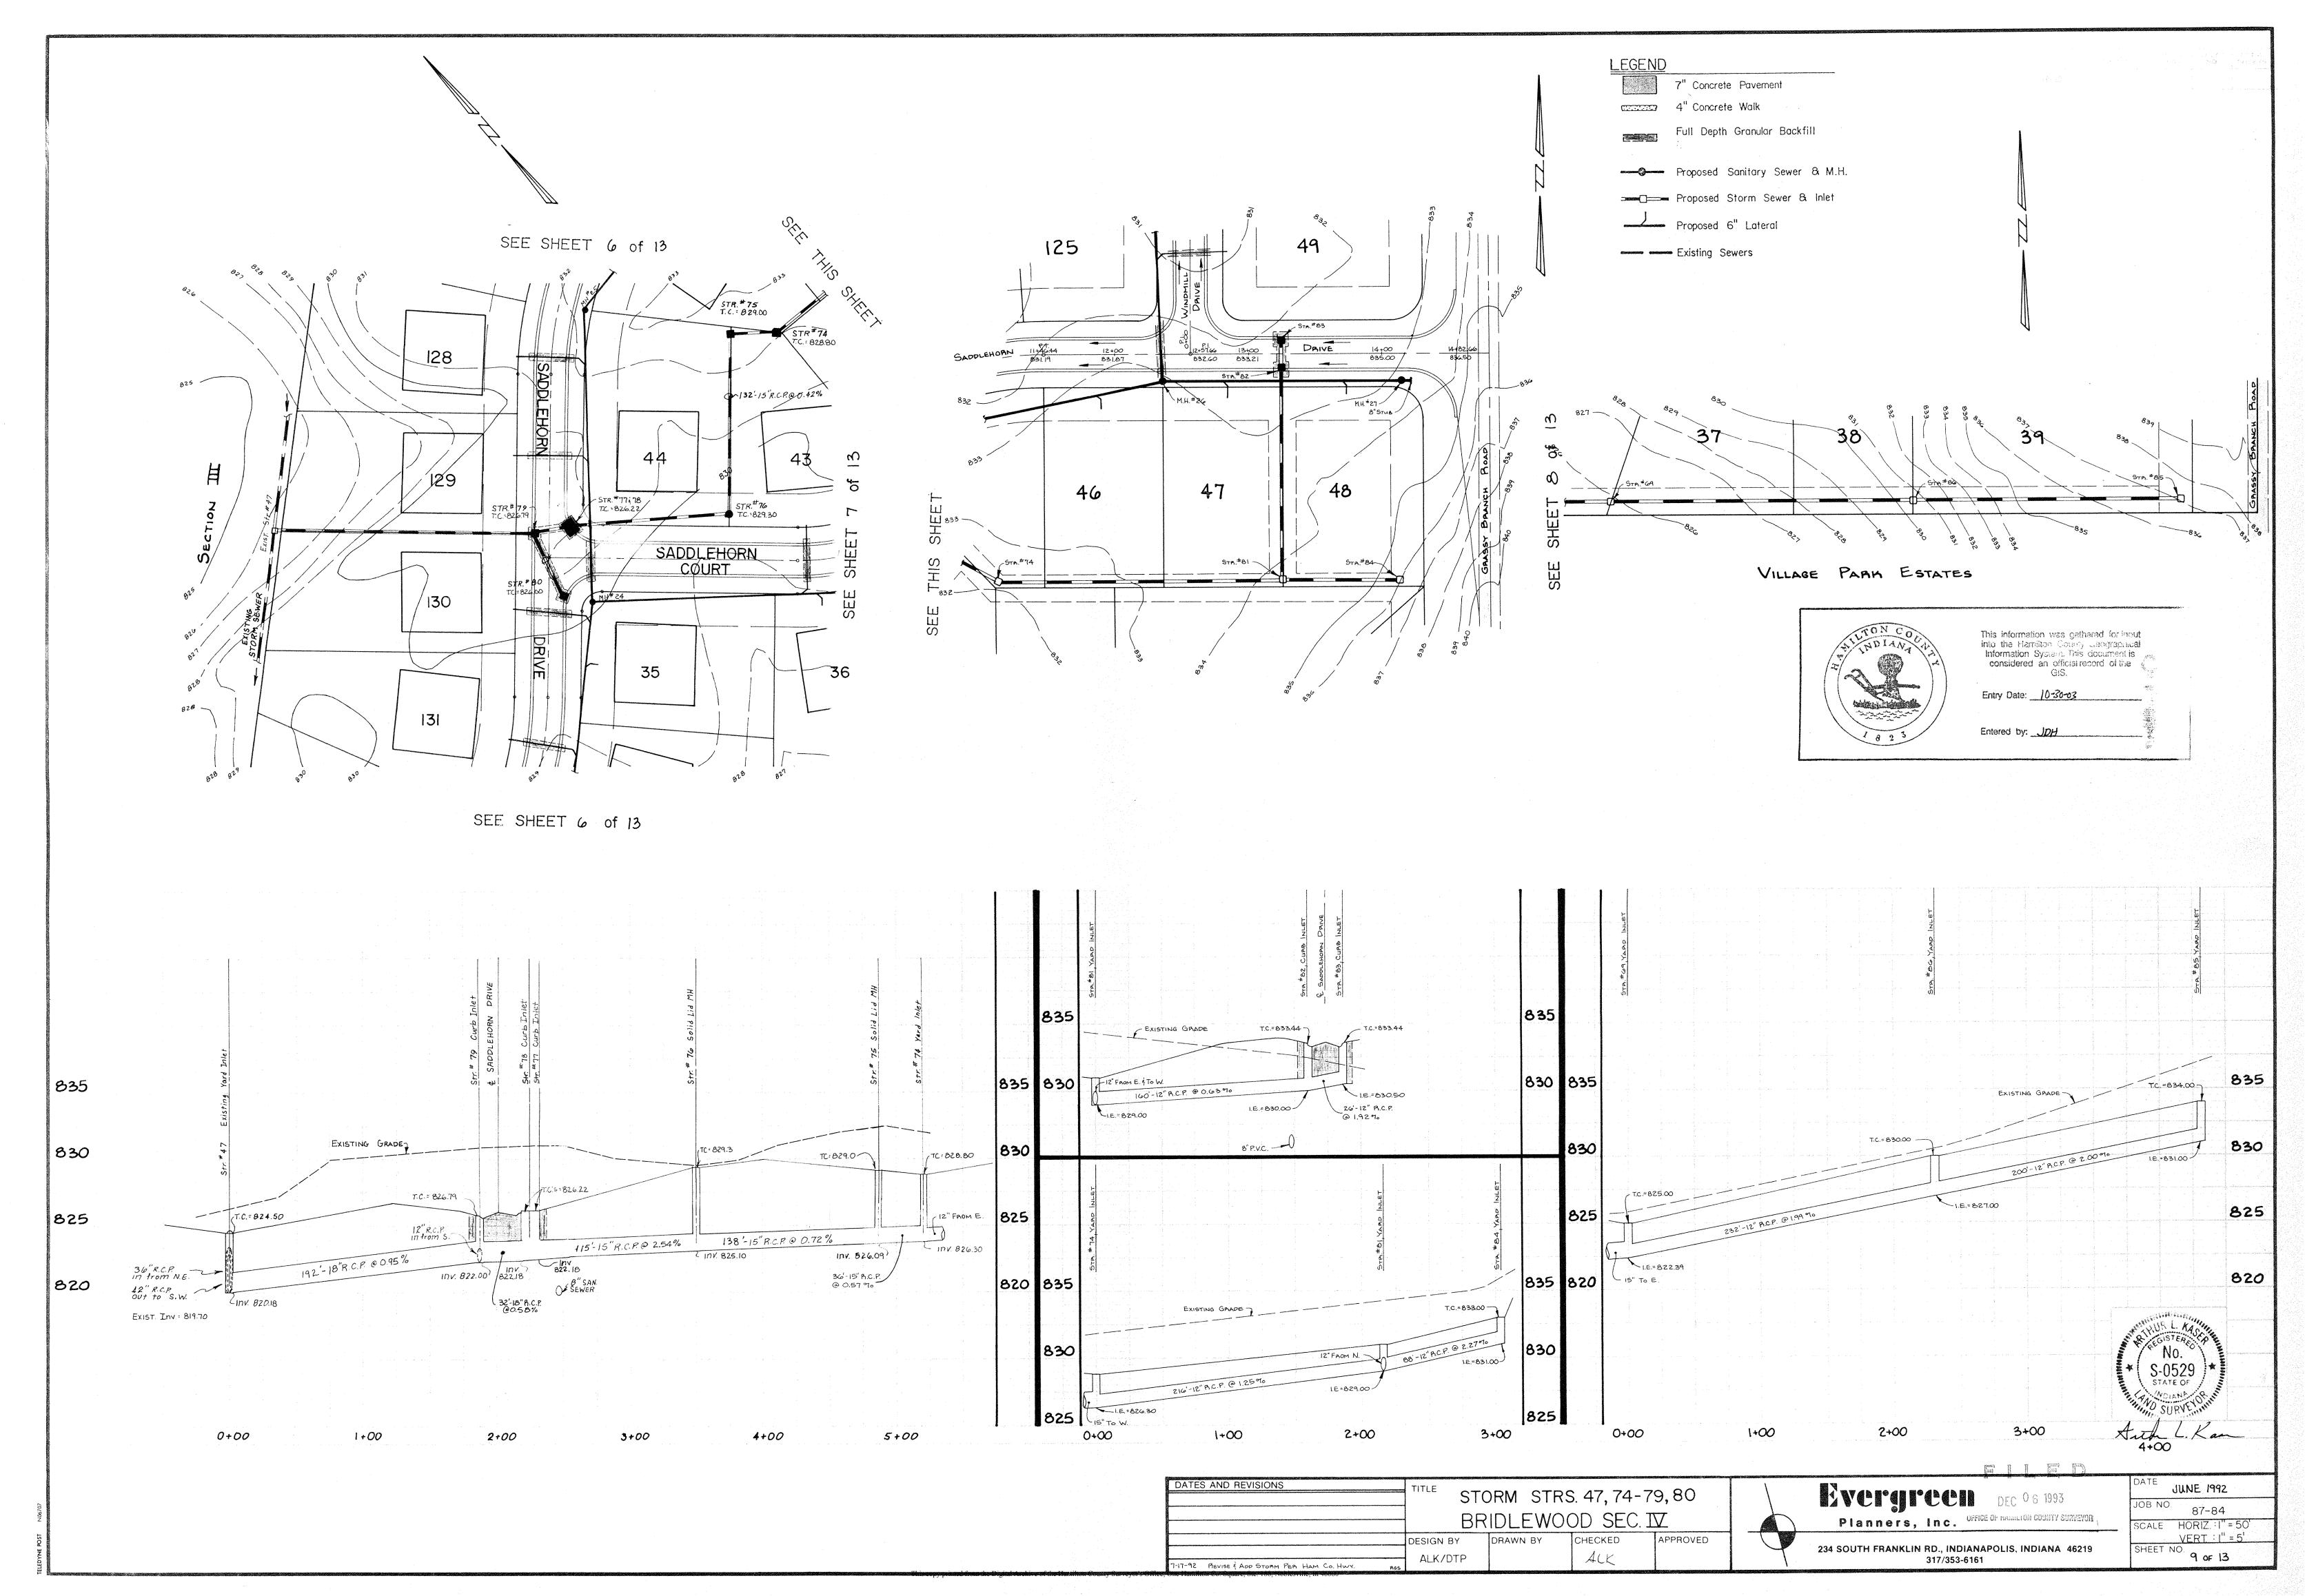

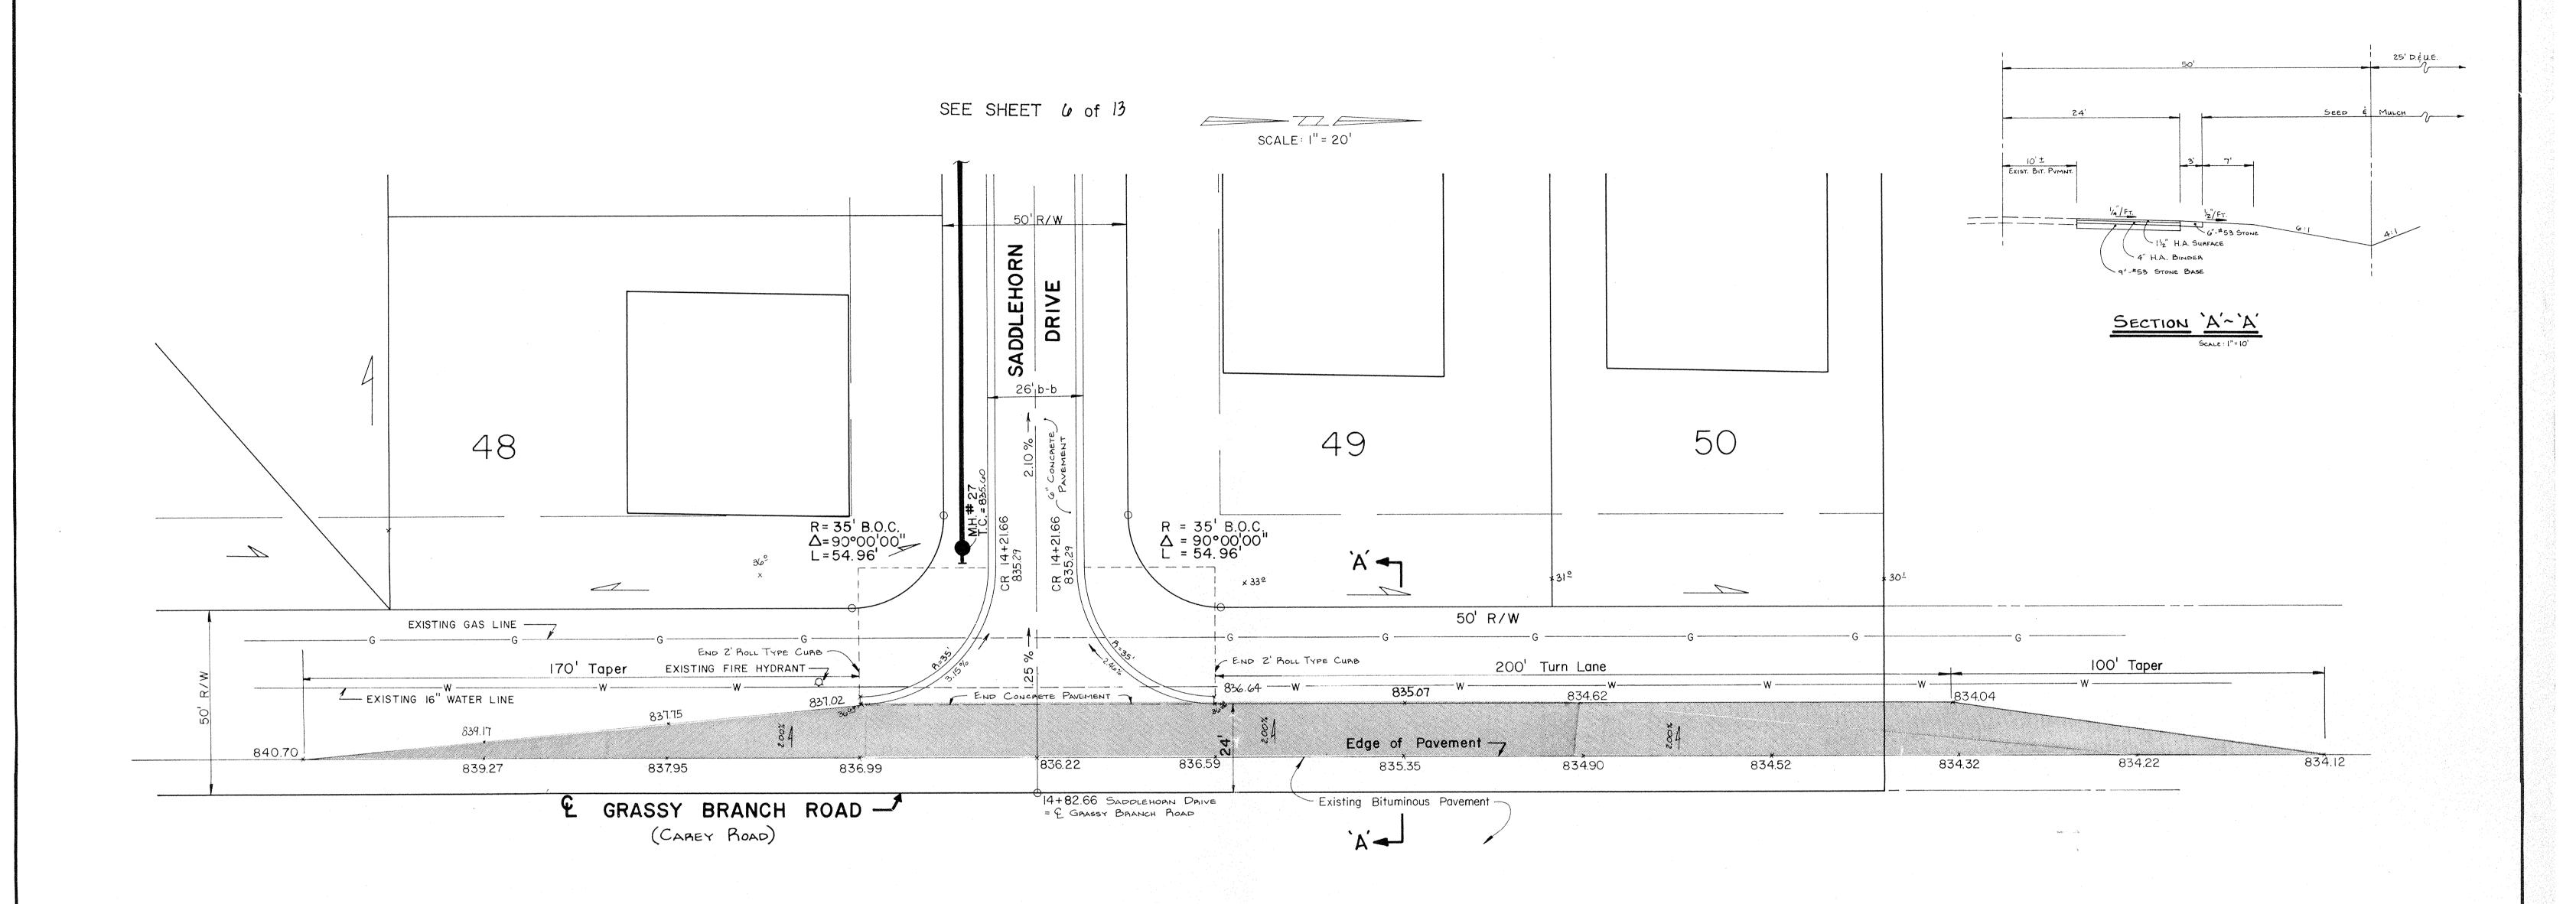


STRUCTURE	CHART

Str. No.	Type	Casting No.*	T.C. El.	Inv. El.
65	Curb Inlet	R-3501-TR	822.80	819.80
66	Curb Inlet	R-3501-TL	822.80	819.68
67	Curb Inlet	R-3501-TR	821.90	818.35(E)
				817.35(W)
68	Concrete Slopewall	Name Addres Name Stripe	marijan (1989) sidaga bisant	815.80
69	Yard Inlet	R-4343	825.00	822.39
70	Yard Inlet	R-4343	823.90	820.83
71	Curb Inlet	R-3501-TL	824.20	820.22
72	Curb Inlet	R-3501-TR	824.20	820.02
73	Solid Lid Manhole	R-1077-A	825.10	819.68
74	Yard Inlet	R-4343	828.80	826.30
75	Yard Inlet	R-4343	829.00	826.09
76	Solid Lid Manhole	R-1077-A	829.30	825.10
77	Curb Inlet	R-3501-TL	826.22	822.18
78	Curb Inlet '	R-3501-TR	826.22	822.18
79	Curb Inlet	R-3501-TL	826.79	822.00
80	Curb Inlet	R-3501-TR	826.00	822.22
81	Yard Inlet	R-4343	831.00	829.00
82	Curb Inlet	R-3501-TR	833.44	830.00
83	Curb Inlet	R-3501-TL	833.44	830.50
84	Yard Inlet	R-4343	833.00	831.00
85	Yard Inlet	R-4343	834.00	831.00
.86	Yard Inlet	R-4343	830.00	827.00
169	Yard Inlet	R-4343	825.00	821.65

* Neenah Cat. No. or Equal

M.H. Chart						
M.H. No.	T. C.	Inv. In.	Inv. Out			
21	827.20	814.93	814.83			
22	825.30	816.81	816.71			
23	825.40	817.78	814.68			
24	827.40	818.75(NE)	818.65			
		818.85(SE)				
25	829.30	822.63	822.53			
26	832.70	824.79(E)	824.69			
xa 37		824.89(N)				
27	835.60	826.65	826.55			
36	830.90	823.90	823.80			
37	836.50	allowed strongs strongs contains	829.80			
38	831.40	made water from	826.63			

*Neenah Casting No. or Equal

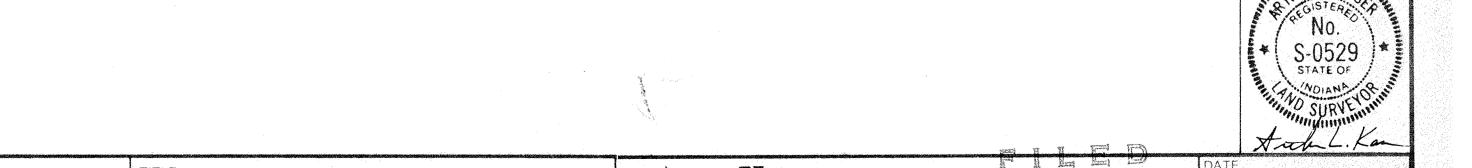

DATES AND REVISIONS

ENTRANCE DETAIL

BRIDLEWOOD SEC. IV

DESIGN BY

DESIGN BY

ALK/DTP

MFH

DATES AND REVISIONS

TITLE

ENTRANCE DETAIL

APPROVED

APPROVED

ALK/DTP

MFH

Planners, Inc.


OFFICE OF HAMILTON COUNTY SURVEYOR

234 SOUTH FRANKLIN RD., INDIANAPOLIS, INDIANA 46219
317/353-6161

JOB NO 87-84

SCALE
AS SHOWN
SHEET NO. 12

SHEET NO. 10 of 13

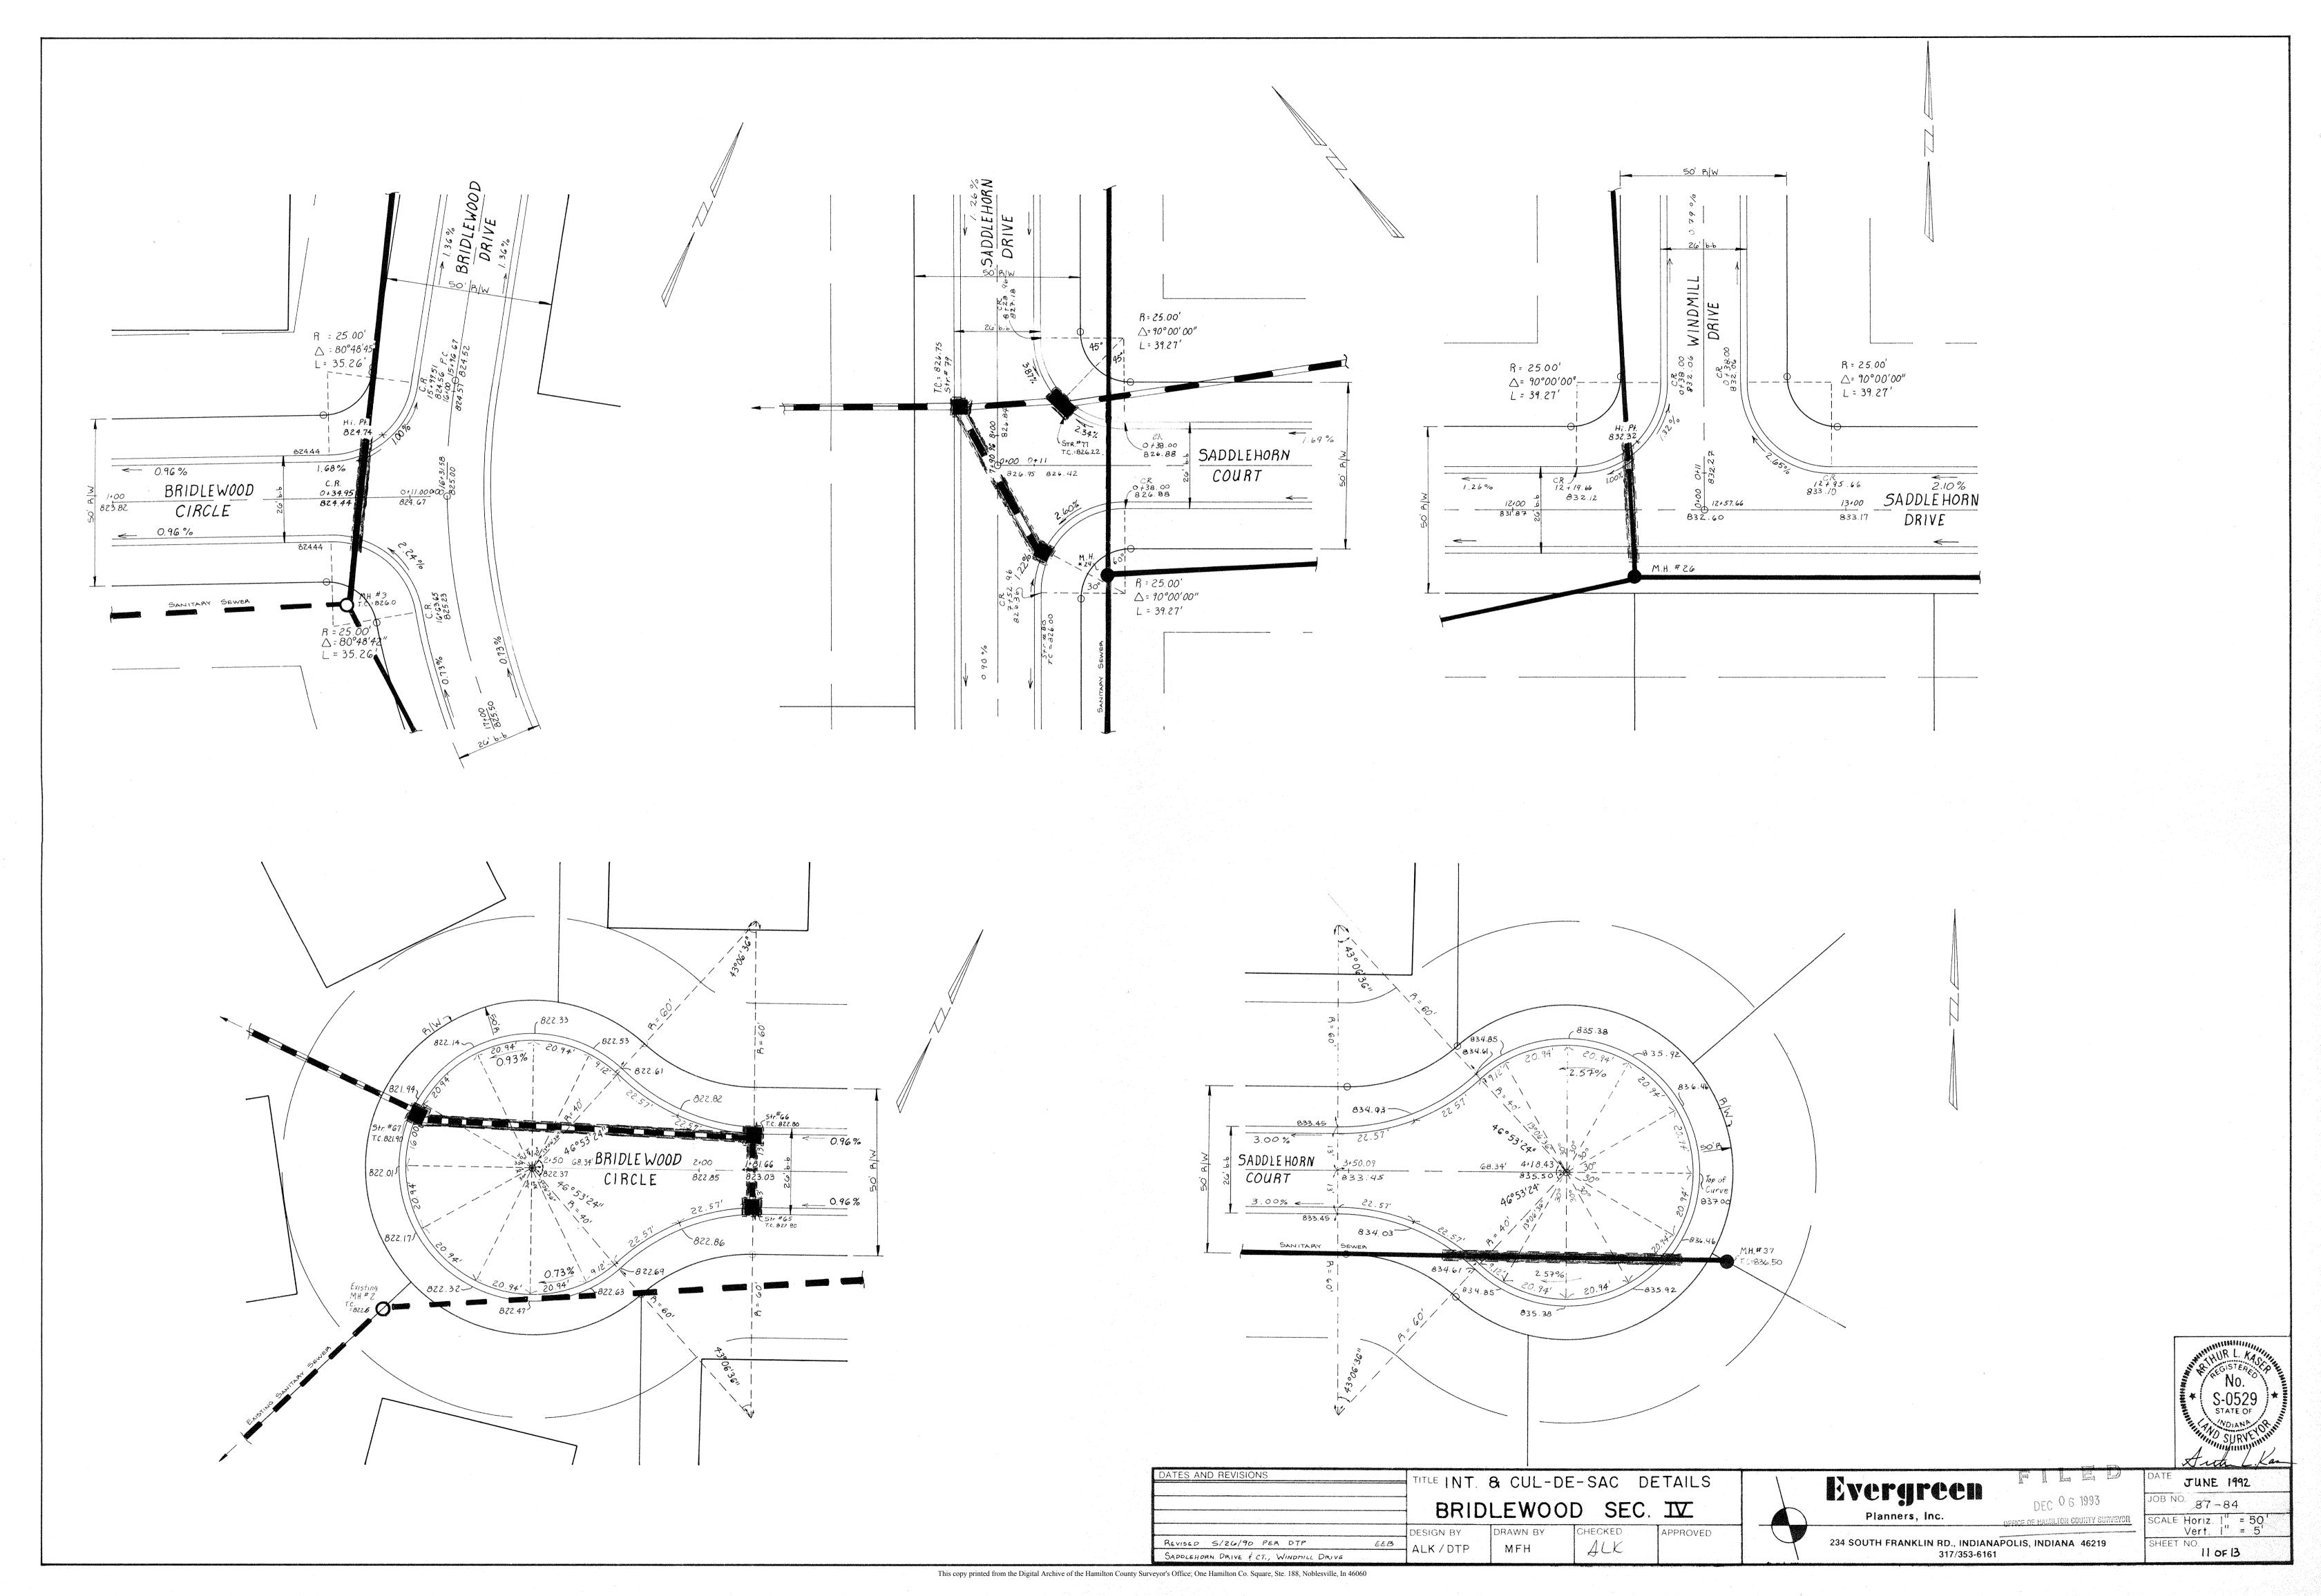

GENERAL SITE WORK NOTES

- 1. All construction work and material shall meet the specifications of the Indiana Department of Highways 1988.
- 2. All trenches under or within five (5) feet of the street pavement shall be backfilled to the subgrade with granular material as directed by the engineer. Backfill shall be compacted per Section 211.
- 3. Before earthwork is commenced, the contractor shall remove the topsoil in the area of the street and house pads that require fill. This topsoil shall be stockpiled as directed by the engineer in sufficient quantity so as to allow for the placement of at least three (3) inches over all disturbed areas before mulch seeding. The remainder of the topsoil shall be distributed in the front and rear yards.
- All files of aced waden poved areas and house pads are to be ms and the resonance by Atandard practor (ASTM 0-698)
- security with Section 20%; * Minimum elevation for the top of the slab of slab type structures or * * If a crawl space or basement is used, the flood protection grade * * would pertain to the lowest land grade around the exterior of the * * building, is two (2) feet above the 100-year flood elevation.
- 5. Temporary silt settlement basins, two feet in depth shall be excavated at the entrance to storm structures, as directed by the engineer.
- 6. Storm and Sanitary sewer material and installation shall be in direct accordance with the STANDARD SPECIFICATIONS FOR STORM AND SANITARY SEWER CONSTRUCTION IN MARION COUNTY, INDIANA as approved on the 20th day of June, 1974. The sanitary sewer contractor shall furnish to the owner certified infiltration tests showing that the leakage outward or inward (exfiltration or infiltration), by an air test (ASTM C828 preferred) shall not exceed 200 gallons per inch of pipe diameter per mile per day and deflection tests for PVC or Truss pipe for 100% of the project and any other tests required for acceptence of sewers by the Department of Public
- 7. Pavement is to be placed on a prepared subgrade with no traffic on the subgrade prior to paving, as per 1988 I.D.O.H. Specifications, Section 207.
- 8. Concrete pavement to be placed as per 1988 I.D.O.H. Specifications. Asphalt pavement to be placed as per 1988 T.D.O.H. Specifications, Section 400.
- For additional information see Street Detail Sheet.
- 9. All construction within the dedicated right of way or in areas dedicated to the public shall conform to the City of Indianapolis, Department of Transportation's STANDARDS for STREET & BRIDGE DESIGN and CONSTRUCTION as adopted on the 17th day of May 1972 and its periodic revisions.
- 10. All natural areas which are disturbed by site development construction shall be seeded with a mixture of 60 pounds per acre of grass and 60 pounds per acre of Kentucky 3. Fescue or Alta Pescue.
- Oriveways and sidewalks, unless otherwise noted, are not to be installed as part of these plans and are the responsibility of the Hysbual home builder.
- Prior to start of construction, a pre-construction conference be scheduled on site with Contractor, Subcontractor. beveloper, Engineer for the Developer, or City Engineer (844-8900), land Utilities Department.
- 13. All City of Lawrence permits shall be obtained prior to start of gonstruction:

DURCHRIC AND TELEPHONE

- 1. Conduit shall be required for all crossings under pavement areas.
- 2. Granular backfill shall be required for all crossings under pavement areas. and compacted per Section 211. 3. Concrete pads for electric and telephone transformers shall be set at the opproximate ground grade as shown on the Site Development Grading Plans for the respective locations.

CONCPETE CURB AND WILKS.

edition.

- See Detail Sheet for type and details. Curbs and walks within existing or proposed right of way shall be constructed in accordance with General Ordinance No. 49, 1972.
- 2. Concrete shall be ready mix Portland cement conforming to A.S.T.M. C-150, and water. Aggregate shall conform to A.S.T.M. C-33. Compressive strength of concrete at 28 days shall be 4000 p.s.i. Where required, reinforcement shall be welded steel wire fabric conforming to A.S.T.M. A-185.

3. Application.

- A. Place concrete only on a moist, compact subgrade or base free from loose material. Place no concrete on muddy or frozen subgrade.
- B. Concrete shall be deposited so as to require as little rehandling as practical. When concrete is to be placed at an atmospheric temperature of 35 F. or less, Paragraph 702.10 of the I.D.O.H. Specifications, 1985 edition, shall apply.
- C. Except as otherwise specified, cure all concrete by one of the methods described in Section 501.17 of the I.D.O.H. Specifications, 1985

SANITARY SEWER SPECIFICATIONS

- 1. Current City of Indianapolis Sanitary Sewer District, County and State specifications shall prevail as to materials and methods of construction.
- 2. Sanitary sewers shall be installed in accordance with the Indiana State Board of Health requirements.
- 3. Sanitary sewers shown on the construction plans may be Poly-Vinyl Chlorine Pipe in accordance with A.S.T.M. D-3034 (S.D.R. 35),
- or A.B.S. Truss Pipe, where applicable, in accordance with A.S.T.M. D-2680 (8"-15" pipe and fittings), D-2751 (6" pipe and fittings).
- 4. Construction of the sanitary sewers will not be allowed to commence until a valid SPC-15 permit is obtained from the Department of
- Environmental Management 5. Sanitary manholes shall be precast concrete in accordance with A.S.T.M. C-478. Manhole joints shall be O-RING type.
- 6. Plastic sanitary sewers shall be marked for easy identification.
- 7. Water and sewer line crossings and separations shall be in accordance with Ten States Standards and local codes.
 - a. Where water lines and sewer lines cross and the water line cannot be placed above the sewer line a minimum of 18" with a minimum cover of 48", the sewer line shall be constructed of waterworks grade cast iron pipe with mechanical joints.
 - b. Where water lines and sanitary sewer lines run parallel with one another, a minimum of 10 horizontal separation shall be maintained.
- 8. Buildings shall be serviced by a 6" minimum sanitary sewer lateral. The sewer laterals termination shall be indicated on the surface with a post set immediately above said termination point. The ends shall be plugged and sealed with a water tight clay or plastic disc. Wyes are to be tilted up to 45 degrees from the horizontal, with suitable fittings for all changes in direction, Identified with locator tape.
- 9. The Contractor shall provide the Engineer with "as-built" locations and information for all samitary sewers and laterals including elevations within ten days after completion.
- 10. Manhole sections shall have "O" rings in case of wet conditions, larger stone shall be used to bedding.

STORM SINERS

- 1. Storm sewer structures shall comply with corrent specifications of the City, County and all agencies in respect to design and quality of construction.
- 2. All storm sewer construction inside public right of way, either existing or to be dedicated, shall be in accordance with General Ordinance 49; 1972. Contractor shall notify the Indianapolis Department of Transportation. fourty-eight hours prior to commencement of storm sewer construction.
- 3. Where reinforced concrete pipe is shown on the construction plans it shall be in accordance with A.S.T.M. C-76 Class III Wall "B", unless of herwise specified on the plans.
- 4. Where corrugated motal pipe is shown on the construction plans . If shall be 16 guage unless otherwise specified and shall have the connecting bands and seals as specified by the manufacturer. C.M.R. may be either alordinant pipe or zinc coated steel sheets in accordance with A.S.T.M. A-A44.
- 5. Manholes, catchbasins, and inlets may be prevast concrete, brick or block!
- 6. Precast concrete and steel for manheles and inlets shall be in accordance with A.S.T.M. C-478.
- 7. Castings shall be as shown on the Structure Data Table for the sanufacturer, type, and model number.
- 8. Granular Backfill shall be required for all crossings under pavement areas per D.O.T. Standard 19-01. Granular Backfill shall be compacted per Section 211.

NOTE: Section References refer to 1988 IDOH Standard Specifications.

DATES AND REVISIONS 5-5-88 Per Noise 3,4 file San Sawer spars Hop Specifications and the second s CII The Land State of the State

IDRAWN BY


The State of the State Storm Sever "B. (BILL) DESIGN BY

APPROVED CHECKED HASP



JUNE 1992 87-84 No Scale

234 SOUTH FRANKLIN RD. INDIANAPOLIS, INDIANA 45219 12 OF 13 317/353-6161

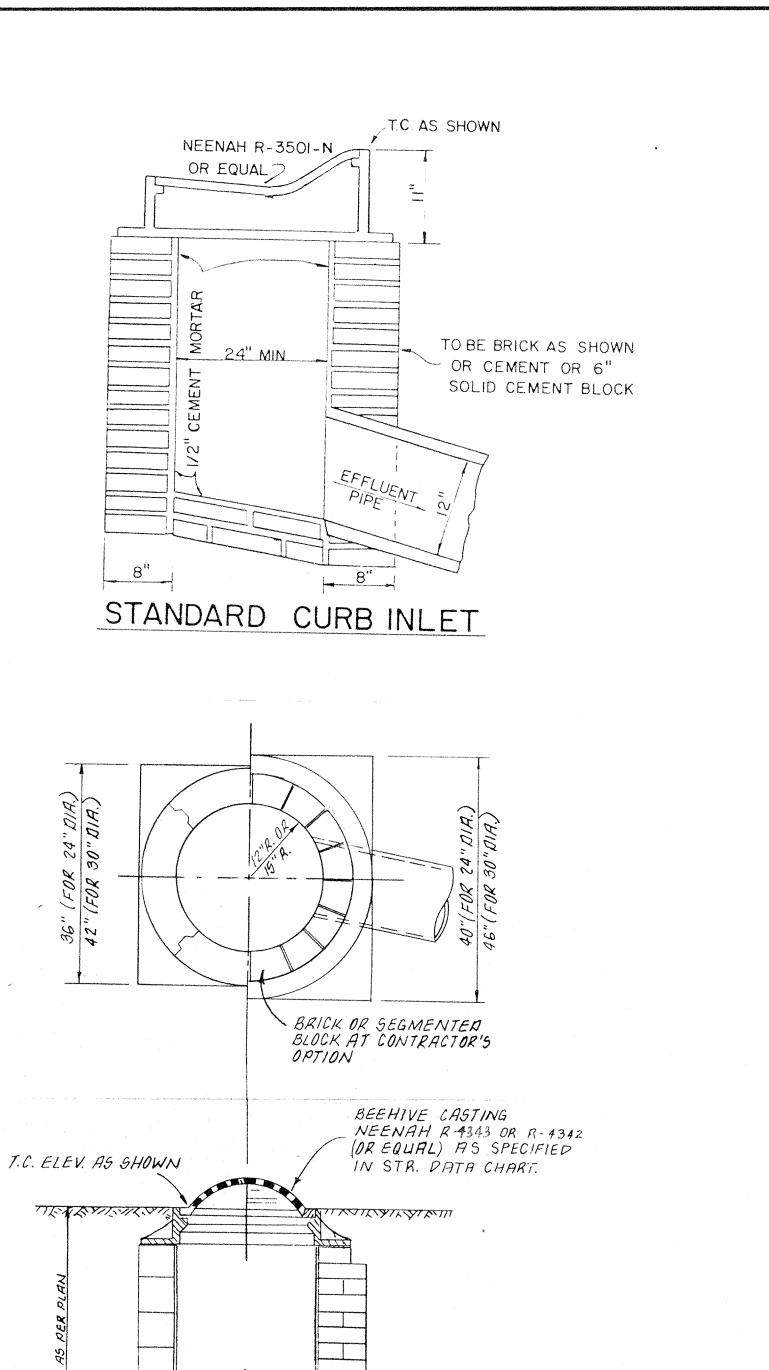



FOR SAFETY REASONS:

deeper than 5 feet.

Initial Backfill


Class | Bedding

Contractor will be responsible to either use shoring, sheeting or a sewer box on all sewer construction


6"Min.

per ASTM-2321 4"To 6" Min.


PVC ASTM D2680
TRUSS
PIPE
Spring Line

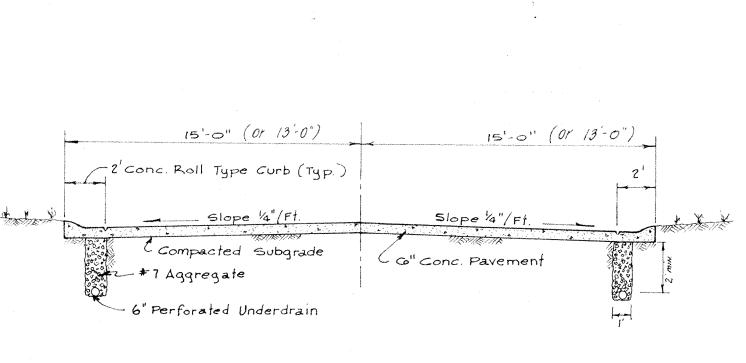


TYPICAL PAVEMENT SECTION

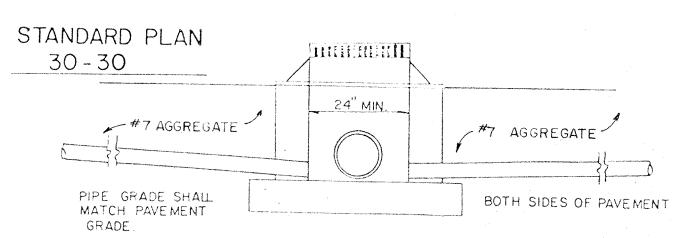



INLET DETAIL SHOWING SUBSURFACE DRAINAGE

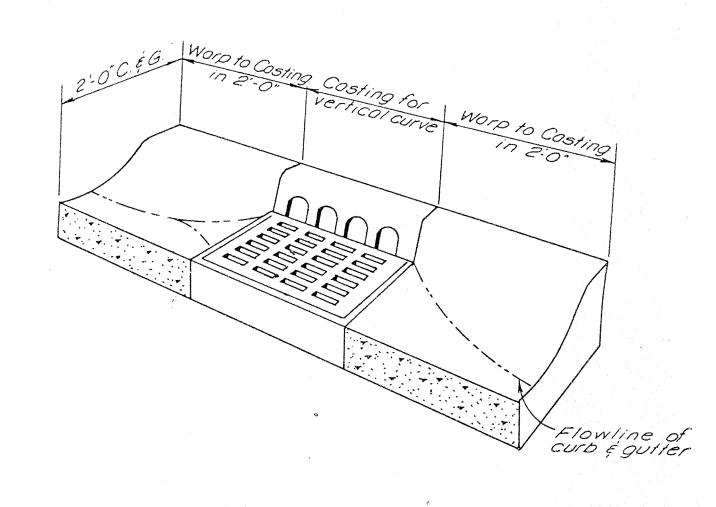


WARP PATTERN CURB ÉGUTTER INTO CASTING

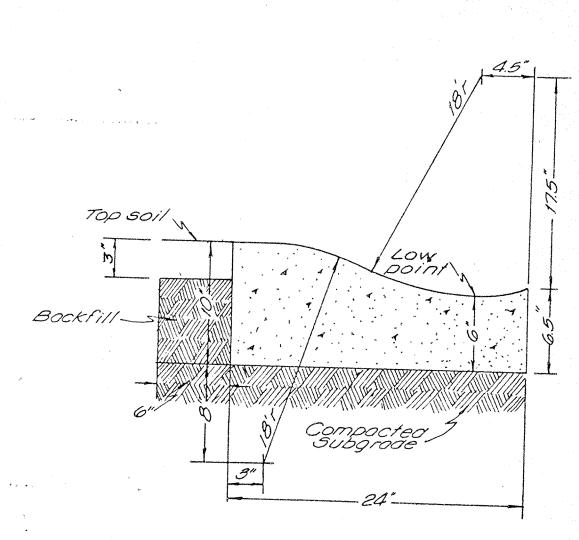

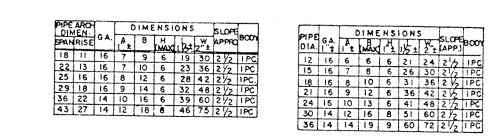


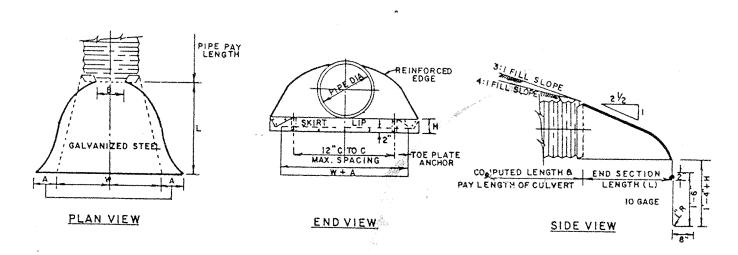


END SECTIONS AND TOE PLATE ANCHORS SHALL CONFORM TO ALL APPLICABLE REQUIREMENTS AS SET OUT IN THE STANDARD SPECIFICATIONS. MULTIPLE PANEL BODIES SHALL HAVE LAP SEAMS WHICH SHALL BE TIGHTLY JOINTED WITH 3/8 0 GALVANIZED RIVETS OR BOLTS. THE TOE PLATE ANCHOR SHALL BE CONSTRUCTED OF 10 GAGE GALVANIZED STEEL AND BE REQUIRED ON ALL STEEL PIPE END SECTION. IT SHALL BE MATCHED - PUNCHED TO FIT HOLES IN SKIRT LIP, AND SUPPLIED LOOSE, COMPLETE WITH 3/8" g
GALVANIZED BOLTS. COST THEREOF SHALL BE INCLUDED IN THE CONTRACT UNIT PRICE PER EACH FOR "PIPE END SECTION" WHERE VITRIFIED CLAY CULVERT OR CAST IRON CULVERT PIPE IS USED A "PIPE END SECTION" COMPARABLE TO THAT AS SHOWN FOR METAL OR CONCRETE SHALL BE FURNISHED AND SHALL BE AS APPROVED BY THE ENGINEER. END SECTIONS WILL BE PAID FOR AT THE CONTRACT UNIT PRICE EACH FOR "PIPE END SECTION"COMPLETE IN PLACE PIMPLED CONNECTION BAND MAY BE USED TO CONNECT PIPE END SECTION TO HELICALLY CORRUGATED PIPE.

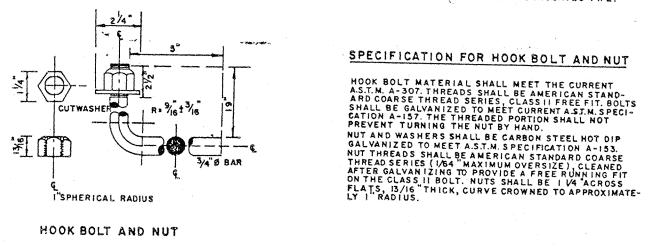


METAL END SECTION DETAIL

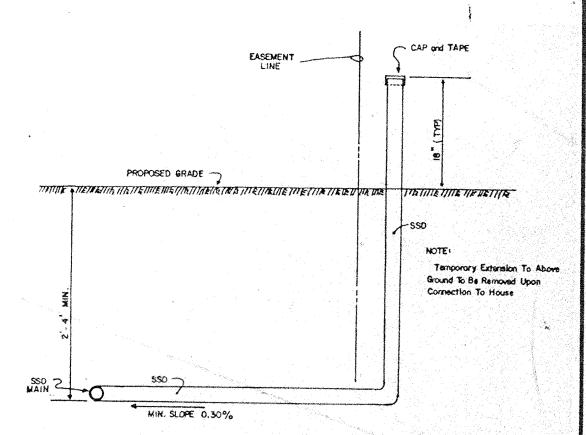

TYPICAL SSD CONNECTION TO INDIVIDUAL LOTS

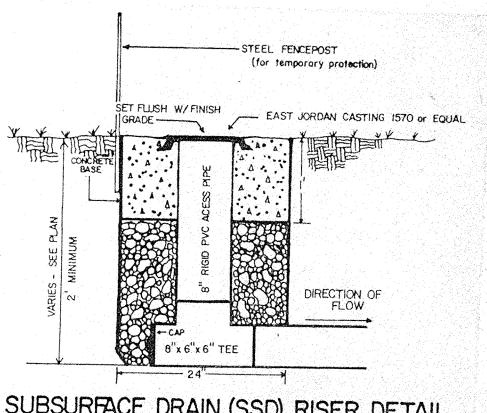


SUBSURFACE DRAIN (SSD) RISER DETAIL

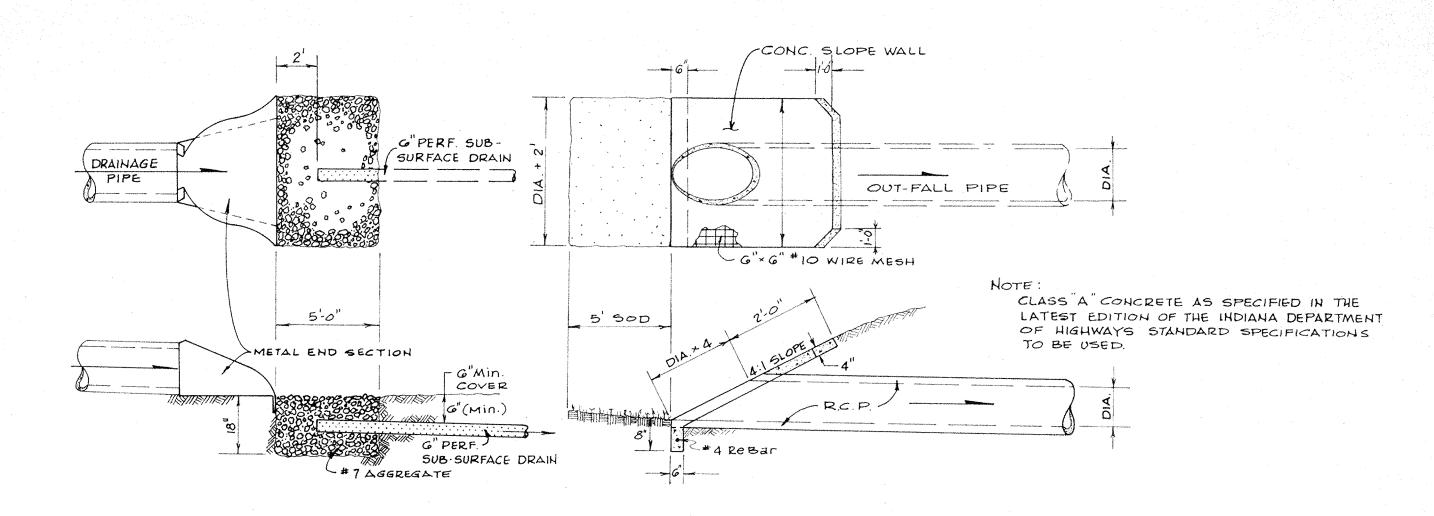

SPEACIAL OUT-FALL TREATMENT

CONC. SLOPE WALL DETAIL

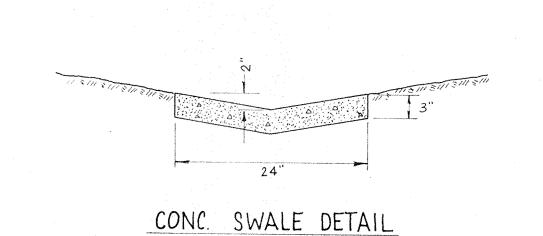

8/13/92 CHANGED 4" SSD TO 6" SSD &CK 8/8/88 ADDED TRENCH DETAIL

MISC. DETAILS APPROVED DRAWN BY CHECKED






Evergreen DEC 0 6 1993 Development Corporation OFFICE OF HAMILTON COUNTY SURVEYOR 234 SOUTH FRANKLIN RD., INDIANAPOLIS, INDIANA 46219 317/353-6161

Als shown SHEET NO 13 OF 13


TRENCH SECTION PVC ASTM D2680 PVC ASTM D2680
Class | Bedding Material as per ASTM-2321
(1-0.0.T. No.4 stone is acceptable class | Bedding Material).
Bedding and Initial Backfill Material will extend from a minimum of 4" below bottom of pipe to a minimum of 6 above the top of the pipe.

2/27/87 CHANGE YARD INET CASTING NO. 2/27/87 ADDED SSD RISER DETAIL ALK 6/3/86 Revised TYP P'umnt Sect. CM

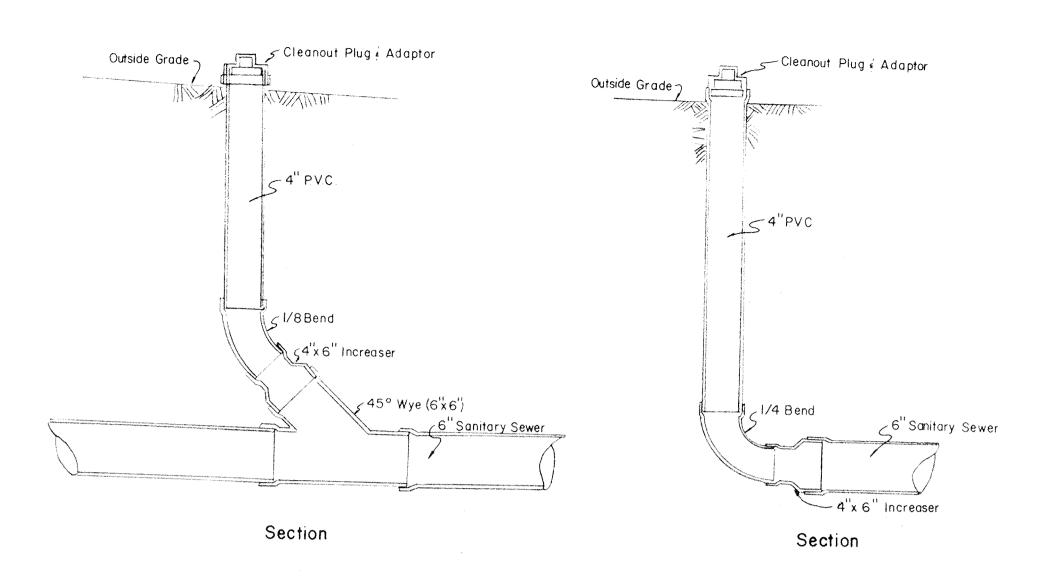


CLEAN OUT - TYPE I


CLEAN OUT - TYPE II

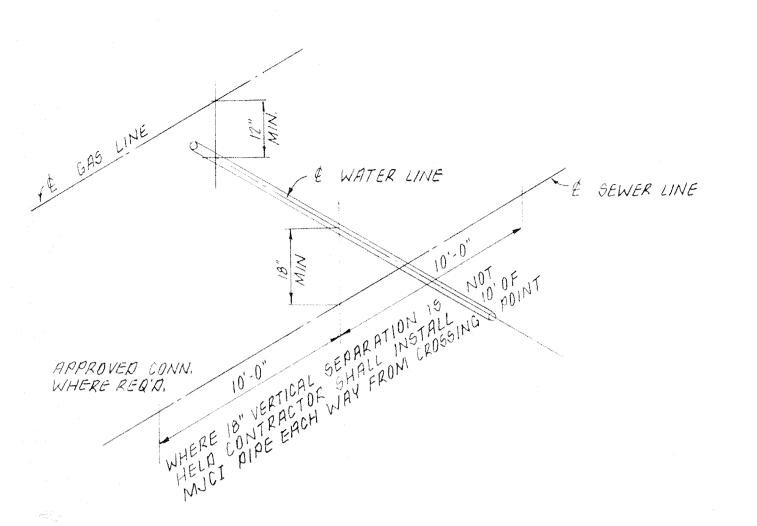

UTILITY CROSSING DETAIL

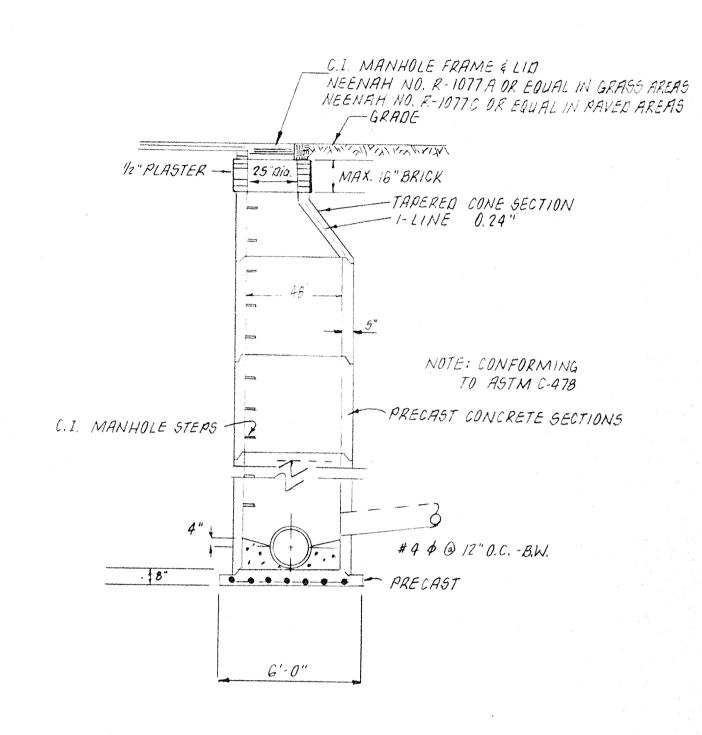


STANDARA MANHOLE FOR SEWERS LESS THAN 24" DIA.

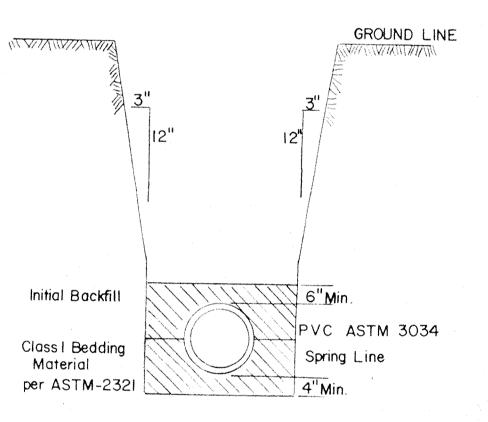

TRENCH SECTION

PVC ASTM 3034

PVC ASTM 3034 is an acceptable alternative to VCP. If flexible conduit shall be Class | Bedding Material as per ASTM-2321

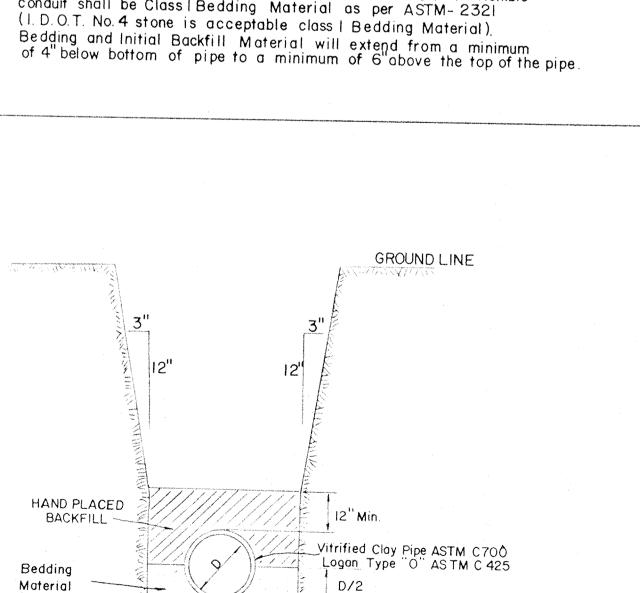


D/8 (4"Min.)

TRENCH SECTION

Substitute 6" of

4 Stone in lieu of 4" bedding material.

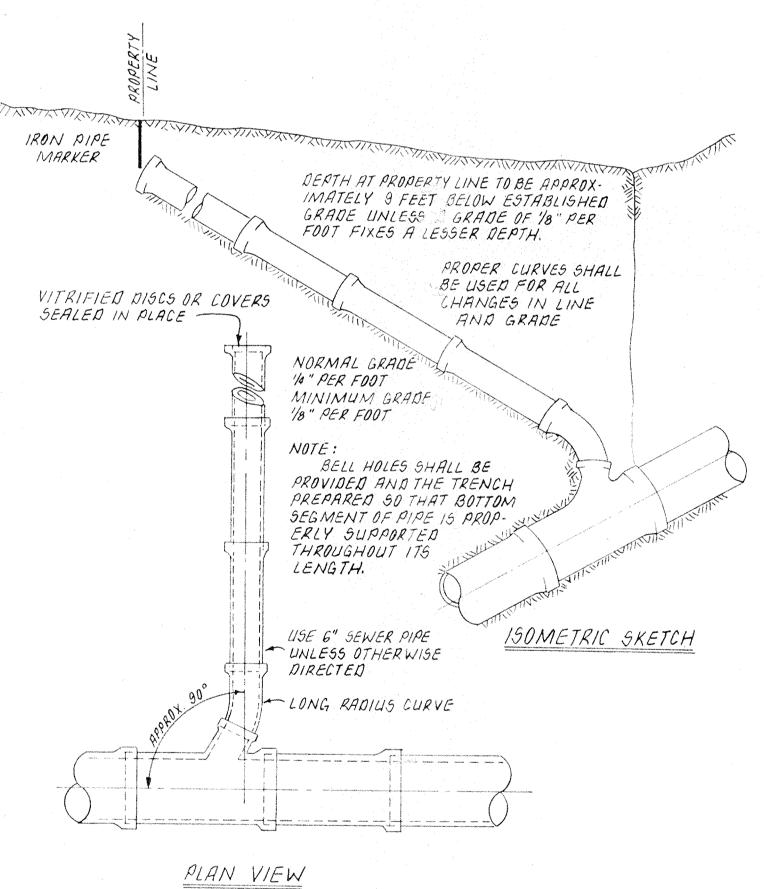

HOUSE CONNECTION TO MAIN GEWER

GENERAL NOTES:

1. Utility Companies

Electric -

Public Service Indiana General Office 839-9611

Gas -

Water and Sewer - Hamilton Western Utilities

Buried Cable 800-382-5544

Telephone -


Indiana Gas General Office 926-3351


Citizens Gas - Attention Max Howard

Indiana Bell Telephone Company

General Office 924-3341 Underground Location 800-382-5544

- 2. Contractor shall contact all utility companies to have underground facilities located prior to any excavation work.
- 3. Elevations at structures are pipe inverts (Inv) or top of casting (T.C.).
- 4. Infiltration/exfiltration testing shall be performed in accordance with the requirements of the Indiana State Board of Health.

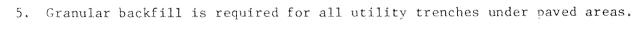

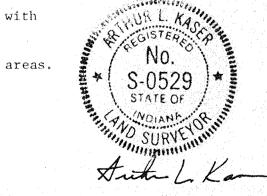

DATES AND REVISIONS					
	TITLE			EC 0 6 1993	DATE JUNE 1992
		R DETAIL	_S		JOB NO. 87-84
	DESIGN BY DRAV	VN BY CHECKED	APPROVED	Development Corporation OFFICE OF HAMILTON COUNTY SURVEYOR	SCALE As shown
				234 SOUTH FRANKLIN RD., INDIANAPOLIS, INDIANA 46219 317/353-6161	SHEET NO BA of 13